

FLA Manufactured Building Program 2601 Blair Stone Road Tallahassee, Florida 32399-0772 Phone: 850.487.1824• Fax: 850.414.8436

Halsey Beshears, Secretary

Ron DeSantis, Governor

July 07, 2020

doug oliver

Cook Portable Warehouse 100 Douglas Street Valdosta, GA 31601

RE: Manufacturer Certification, ID MFT-1435; Expiration Date: July 07, 2023

Dear doug oliver

It is my pleasure to inform you that Cook Portable Warehouse, located at 100 DOUGLAS STREET, VALDOSTA, GA 31601, has been approved under the Manufactured Buildings Program, as provided for under Chapter 553, Part I, Florida Statutes, to manufacture Storage Sheds, Manufactured Buildings for installation in Florida.

Construction or modification on a manufactured building cannot begin until the Third Party Agency has approved the plans in accordance with the current Florida Building Code. Your Third Party Agency is a contractor for the Department and has statutory authority and responsibilities that must be met to maintain approved status. You may expect and demand quality plans review and inspections.

Each Code change will make your plans obsolete until they have been reviewed, approved and indicated [on the cover page of the plans] for compliance with the Code by your Third Party Agency for plans review. Please ensure that your plans are in compliance and are properly posted on our website. All site-related installation issues are subject to the local authority having jurisdiction.

The Department's contractor will make unannounced monitoring visits at least once each year. You must grant complete access to your manufacturing facility and records to remain in compliance with the rules and regulations of this program.

Your certification is approved for three years from this date. You will receive a renewal notice by Email generated by the BCIS (www.floridabuilding.org) for online renewal. If you have questions you may contact Robert Lorenzo at 850-717-1835 or our FAX at 850-414-8436.

Please visit our website at www.floridabuilding.org to see valuable information on the Florida Manufactured Buildings Program. A copy of this letter must accompany applications for local building permits.

Sincerely, Part Lugo

Robert Lorenzo

Manufactured Buildings Program

cc: Top Line Engineering, LLC



Tel +1 407 304 5560 Fax +1 407 304 5561 intertek.com/building



July 23, 2018

Mr. Thomas Campbell
Florida Department of Business and Professional Regulation
Manufactured Building Program
1940 North Monroe Street
Suite 90A
Tallahassee, Florida 32399-0772

RE: Plan Approval: Residential Lawn Storage Shed

Manufacturer: Cook Portable Warehouse

Agency Plan Number: 2017-20 R-2

Dear Mr. Thomas,

Professional Service Industries Inc., an Intertek company ("Intertek-PSI"), part of Intertek¹ Building Science Solutions, in pursuant to the requirements of the Florida Department of Business and Professional Regulations, the above referenced documents have been reviewed for compliance with:

2017 Florida Building Code, 6th Edition

2014 NEC, NFPA 70

These plans comply with Florida Product Approval Rule 61G20-3.006 (FAC). A signed and sealed set of plans are maintained on file in the Third-Party Agency office of PSI.

All mandatory comments have been satisfied and plans are approved for construction by a modular building manufacturer that is currently approved by the Department of Business and Professional Regulations.

If you have any questions or require my assistance in any way, please do not hesitate to contact me.

Yours sincerely,

Professional Service Industries, Inc.

Richard Olds, ICC #5107840

Plans Examiner

Business Science Solutions

Peter Craig

Department Manager
Building Science Solutions

CC: Doug Oliver - Cook Portable Buildings, Inc. - doliver@cookstuff.com



COOK PORTABLE WAREHOUSES

100 DOUGLAS ST., VALDOSTA, GA 31601 132 CENTRAL INDUSTRIAL ROW, PURVIS, MS 39475 1398 HWY 95 NORTH, BASTROP, TX 78602

LOFTED BARN SHED

STATE OF FLORIDA

	Design Criteria
BUILDING CODE	6TH EDITION, 2017 FLORIDA BUILDING CODE
ELECTRICAL CODE	2014 NEC, NFPA70
BUILDING TYPE	RESIDENTIAL LAWN STORAGE SHED
MANUFACTURER	COOK PORTABLE WAREHOUSES
AGENCY	PSI
AGENCY PLAN NUMBER	LOFTED BARN 2017 FBC
CONSTRUCTION TYPE	V-B
FIRE PROTECTION	В
FIRE SUPPRESSION SYSTEM	NO
OCCUPANCY	U - UTILITY
NUMBER OF OCCUPANTS	0
ALLOWABLE # OF STORIES	1
WIND INFORMATION	160 MPH ULTIMATE; EXPOSURE C, CATEGORY I; ENCLOSED; +/- 0.18 INTERNAL PRESSURE COEFFICIENT; 15' HEIGHT
FLOOR LIVE LOAD	40.0 PSF
FLOOR DEAD LOAD	4.0 PSF
ROOF LIVE LOAD	20.0 PSF
ROOF DEAD LOAD	7.0 PSF
WALL DEAD LOAD	3.0 PSF
UNINHABITED LOFT LIVE LOAD	10.0 PSF
GROUND SNOW LOAD	0.0 PSF
FIRE RATING OF EXTERIOR WALLS	0
"R" RATING OF FLOOR, WALL, AND ROOF	R-0, R-0, R-0
MODULES PER BUILDING	1
SQUARE FOOTAGE	LESS THAN 719 SQ. FT.
EXEMPT FROM ENERGY CONSERVATION CODE?	YES
APPROVED FOR HURRICANE PROTECTION USAGE?	NO
DESIGNED FOR HURRICANE PUBLIC SHELTER?	NO

SITE INSTALLED ITEMS:

NOTE THAT THIS LIST DOES NOT NECESSARILY LIMIT THE ITEMS OF WORK AND MATERIALS THAT MAY BE REQUIRED FOR A COMPLETE INSTALLATION. ALL SITE RELATED ITEMS ARE SUBJECT TO LOCAL JURISDICTION APPROVAL.

- THE COMPLETE FOUNDATION
 SUPPORTING AND TIE-DOWN SYSTEM.
- RAMPS, STAIRS, AND GENERAL ACCESS TO THE BUILDING IF NECESSARY.
- 3. GUTTERS AND DOWN SPOUTS ON ALL BUILDINGS WITH EAVES OF LESS THAN 6 INCHES HORIZONTAL PROJECTION EXCEPT FOR GABLE END RAKES.

OCCUPANCY NOTE:

THIS BUILDING IS NOT DESIGNED FOR HUMAN HABITATION AND DOES NOT HAVE RUNNING WATER OR SANITATION SERVICES. THIS BUILDING IS DESIGNED AS A UTILITY SHED TO STORE LAWN EQUIPMENT SUCH AS WHEEL BARROWS, GARDENING SUPPLIES, FLOWER POTS, AND CARDBOARD BOXES WITH VARIOUS SMALL ITEMS.

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CODE REVIEW
Professional Service Industries, Inc.
An Intertek Company
1748 33rd Street
Orlando, Florida 32839
Plans Reviewer: Richard Olds
ICC:#51078400
FL #SMP-45, SMI-76
LSUCC:#002416
Department Manager: Peter Craig

Engineer: Kent Bice
FL License #: 50421
COA# 30468

No 5042

STATE OF

OR

07/13/18

1552 6TH ST., WINTER HAVEN, FL 33880 (863)865-6502

COVER SHEET

DATE: 07/13/18 DRAWN BY: RD

SCALE: AS NOTED CHECKED BY: KMB

SHEET:

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GENERAL NOTES:

- 1. THIS STRUCTURE WAS DESIGNED IN ACCORDANCE WITH THE 6TH EDITION, 2017 FLORIDA BUILDING CODE, (2017 FBC).
- 2. ALL MATERIALS AND LABOR SHALL BE IN ACCORDANCE WITH THE ABOVE CODE AND ALL OTHER APPLICABLE LOCAL CODES AT THE TIME OF MANUFACTURE.
- 3. WRITTEN DIMENSIONS SHALL TAKE PRECEDENCE OVER SCALED DIMENSIONS.
- 4. THE FOUNDATION PLAN IS A SEPARATE SET OF PLANS FOR APPROVAL BY LOCAL MUNICIPALITIES.
- 5. EXTERIOR DIMENSIONS CAN VARY BETWEEN LIMITS SHOWN AT 2' O.C. BUT MEMBER SPACING SHALL NOT EXCEED LIMITS AS INDICATED.
- 6. ALL THE FOLLOWING LUMBER SHALL BE PRESSURE TREATED IN ACCORDANCE WITH AWPA USE CATEGORY UC4B (GROUND CONTACT, HEAVY DUTY)-SKIDS.
- 7. ALL THE FOLLOWING LUMBER SHALL BE PRESSURE TREATED IN ACCORDANCE WITH AWPA USE CATEGORY UC3B (EXTERIOR ABOVE GROUND, UNCOATED OR POOR WATER RUNOFF)-FLOOR JOISTS, PLYWOOD FLOOR DECKING, AND EXTERIOR RATED WOOD STRUCTURAL PANEL SIDING.
- 8. ALL FASTENERS AND CONNECTORS IN CONTACT WITH PRESSURE TREATED WOOD SHALL BE HOT DIPPED GALVANIZED (G185) OR STAINLESS STEEL.
- 9. ALL WINDOWS WITHIN 24" OF DOORS, AND ALL GLASS IN DOORS SHALL BE SAFETY, TEMPERED, OR ACRYLIC PLASTIC SHEET.
- 10. FOR ROOFS WITH ASPHALT SHINGLES AND A SLOPE BETWEEN 2 TO 12 AND 4 TO 12 SHALL HAVE A DOUBLE UNDERLAYMENT APPLICATION AS REQUIRED IN ACCORDANCE WITH SECTION 1507.2.2 OF THE 2017 FBC OR PER SHINGLE MANUFACTURER INSTRUCTIONS.
- 11. UNDERLAYMENT SHALL CONFORM WITH SECTION 1507.2.3 OF THE 2017 FBC OR PER SHINGLE MANUFACTURER INSTRUCTIONS.
- 12. ASPHALT SHINGLES SHALL CONFORM WITH SECTION 1507.2.5 OF THE 2017 FBC ATTACHMENT OF ASPHALT SHINGLES SHALL CONFORM WITH 1507.2.7 OF THE 2017 FBC.
- 13. FASTENERS FOR ASPHALT SHINGLES SHALL CONFORM TO SECTION 1507.2.6 OF THE 2017 FBC.
- 14. TIE-DOWNS SHALL MEET THE REQUIREMENTS OF ALL APPLICABLE CODES.
- 15. THESE PLANS HAVE NOT BEEN DESIGNED FOR HVHZ REQUIREMENTS AS SET FORTH IN THE 2017 FBC OR FOR USE AS A COMMERCIAL BUILDING.
- 16. THE CONTRACTOR SHALL BE RESPONSIBLE FOR VERIFYING ALL EXISTING CONDITIONS.
- 17. THE CONTRACTOR SHALL BE RESPONSIBLE FOR DELIVERY AND PLACEMENT OF LAWN STORAGE UNIT TO ENSURE THE INTEGRITY OF THE BUILDING AND ITS COMPONENT PARTS.
- 18. NO FIELD REVISIONS TO ANY STRUCTURAL COMPONENTS OR DEVIATIONS FROM THESE DRAWINGS SHALL BE MADE.
- 19. THE OWNER AND THE CONTRACTOR SHALL HOLD HARMLESS THE ENGINEER FROM AND AGAINST ALL LIABILITY CLAIMS, DAMAGES, LOSSES AND EXPENSES INCLUDING LEGAL FEES ARISING OUT OF OR RESULTING FROM ERRORS OR OMISSIONS IN THE PERFORMANCE OF THE WORK BY THE CONTRACTOR.
- 20. SECTIONS AND DETAILS ON THE DRAWINGS ARE INTENDED TO BE TYPICAL AND SHALL APPLY AT ALL SIMILAR LOCATIONS, UNLESS OTHER SECTIONS AND DETAILS ARE SPECIFICALLY REFERENCED.
- 21. REFER TO SUPPLIED FASTENING SCHEDULE FOR FASTENING BASED ON CONNECTION AND LOCATION OF MEMBERS AS PER 2017 FBC TABLE 2304.10.1 UNLESS NOTED OTHERWISE.
- 22. BUILDINGS HAVE BEEN DESIGNED FOR LP SMARTSIDE STRAND SUBSTRATE PANEL SIDING, LP SMARTSIDE PRECISION LAP SIDING SHALL BE USED WITH X-STRAPS OR STRUCTURAL SHEATHING AS DETAILED IN THIS PLAN SET
- 23. FASTENERS IN LP SMARTSIDE STRAND SUBSTRATE PANEL SIDING MUST NOT BE INSTALLED IN PANEL SIDING GROOVES IN THE FIELD OF THE PANEL SIDING OR WHEN THE PANEL SIDING GROOVES OCCUR AT CUT EDGES OF THE PANEL SIDING.
- 24. REFER TO THE ICC-ES EVALUATION REPORT ESR-1301 / 3090 FOR ADDITIONAL DATA AND SPECIFICATIONS OF LP SMARTSIDE STRAND SUBSTRATE PANEL / LAP SIDING.
- 25. MAX OPENINGS WIDTHS MUST COMPLY WITH DESIGN RATIOS AS PER ANSI/AF&PA SDPWS-2015. BUILDINGS HAVE BEEN DESIGNED TO HAVE ONLY OPENINGS WITH MAX WIDTHS EQUAL TO THOSE IN THE ENDWALL SHEAR WALL CHART.
- 26. PER SECTION 1609.1.2 OF THE 2017 FBC, STORAGE SHEDS THAT ARE NOT DESIGNED FOR HUMAN HABITATION AND THAT HAVE A FLOOR AREA OF 720 SQUARE FEET OR LESS ARE NOT REQUIRED TO COMPLY WITH THE MANDATORY WIND-BORNE-DEBRIS-IMPACT STANDARDS OF THE 2017 FBC.
- 27. BUILDINGS THAT ARE 400 SQUARE FEET OR LESS AND THAT ARE INTENDED FOR USE IN CONJUNCTION WITH ONE-AND-TWO-FAMILY RESIDENCES ARE NOT SUBJECT TO THE DOOR HEIGHT AND WIDTH REQUIREMENTS OF THE 2017 FBC PER 1010.1.1 (SEE EXCEPTION 8).
- 28. BUILDINGS HAVE BEEN DESIGNED TO HAVE ANCHORS DIRECTLY ATTACHED TO ALL FOUR CORNERS OF THE BUILDING TO RESIST TENSION FORCES FROM LATERAL WIND LOADS.
 THIS DESIGN CONSIDERATION MUST BE MADE BY INSTALLER WHEN ATTACHING ANCHORING SYSTEM TO BUILDING.
- 29. UNLESS NOTED OTHERWISE, ATTACH ALL MANUFACTURED PRODUCTS IN ACCORDANCE WITH MANUFACTURERS SPECIFICATIONS.
- 30. 2X4 SP #2 PRESSURE TREATED LUMBER SHALL BE SUBSTITUTED FOR 2X4 SPF #2 LUMBER IN WALLS FOR USE IN FLOOD PLAINS.
- 31. PER APA PRODUCT REPORT PR-N124, LP SMARTSIDE STRAND SUBSTRATE SERIES TREATED-ENGINEERED-WOOD PANEL AND LAP SIDING IS PERMITTED ON WALLS FOR USE IN FLOOD PLAINS.
- 32. 19/32" LP PROSTRUCT FLOORING WITH SMARTFINISH IS PERMITTED IN LIEU OF 5/8" APA RATED STRUCTURAL SHEATHING ON FLOOR. INSTALL PER MANUFACTURER INSTRUCTIONS.



Engineer: Kent Bice
FL License #: 50421
COA# 30468

M. S.

No. 50421
STATE OF

07/13/18

1552 6TH ST., WINTER HAVEN, FL 33880 (863)865-6502

GENERAL NOTES


DATE: 07/13/18 DRAWN BY: RD

SCALE: AS NOTED CHECKED BY: KMB

SHEET:

SHEET 2 OF 21

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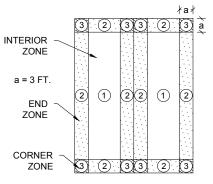


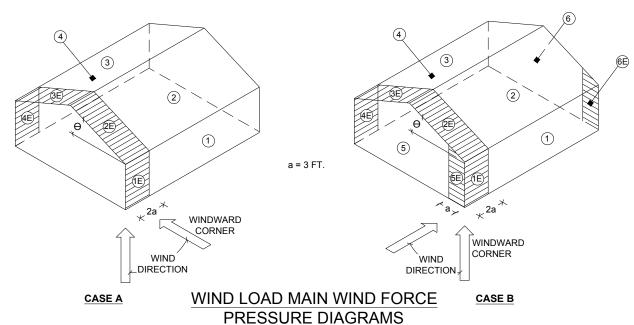DESIGN WIND LOADS - WINDOWS, DOORS, COMPONENTS AND CLADDING


ROOF							
AREA		PRESSURE SF)					
(FT²)	POSITIVE	NEGATIVE					
10	50.9	-55.8					
20	49.6	-52.9					
50	47.7	-49.1					
100	46.2	-46.2					
10	50.9	-65.2					
20	49.6	-62.3					
50	47.7	-58.6					
100	46.2	-55.8					
10	50.9	-65.2					
20	49.6	-62.3					
50	47.7	-58.6					
100	46.2	-55.8					
	AREA (FT²) 10 20 50 100 10 20 50 100 10 20 50	AREA (FT²) DESIGN II (P POSITIVE 10 50.9 20 49.6 50 47.7 100 46.2 10 50.9 20 49.6 50 47.7 100 46.2 10 50.9 20 49.6 50 47.7 100 46.2 10 50.9 20 49.6 50 47.7					

WALLS							
ZONE	AREA (FT²) 10 20 50		PRESSURE (SF)				
		POSITIVE	NEGATIVE				
4		55.8	-60.5				
4		53.2	-58.0				
4		49.9	-54.6				
4	100	47.4	-52.2				
5	10	55.8	-74.7				
5	20 50	53.2	-69.6				
5		49.9	-62.9				
5	100	47.4	-58.0				
	4 4 4 4 5 5 5	ZONE AREA (FT²) 4 10 4 20 4 50 4 100 5 10 5 20 5 50	ZONE AREA (FT²) DESIGN F (P POSITIVE 4 10 55.8 4 20 53.2 4 50 49.9 4 100 47.4 5 10 55.8 5 20 53.2 5 50 49.9				

BUILDING DATA ASCE 7-10 WIND WIND VELOCITY V_{ULT} 160 MPH INTERNAL PRESSURE COEFFICIENT ± 0.18 WIND VELOCITY V_{ASD} 124 (ENCLOSED BUILDING ASCE 7-10) **BUILDING CATEGORY** HEIGHT & EXPOSURE ADJUSTMENT COEFFICIENT 1.21 ROOF DEAD LOAD RESISTING UPLIFT (PSF) 7.0 ROOF ANGLE, ° (DEGREES) **60 DEGREES** 38 DEGREES ON AVERAGE MEAN ROOF HEIGHT 15 WIND EXPOSURE CATEGORY



WIND LOAD COMPONENT AND CLADDING ROOF PRESSURE DIAGRAM

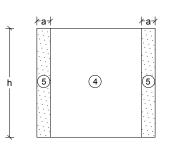

C&C WALL ELEVATION DIAGRAM

a = 3 FT. MAX. h = 8.6 FT.

NOTES:

- 1. FOR EFFECTIVE AREAS BETWEEN THOSE GIVEN ABOVE THE LOAD MAY BE INTERPOLATED, OTHERWISE USE THE LOAD ASSOCIATED WITH THE LOWER EFFECTIVE AREA.
- 2. PLUS AND MINUS SIGNS SIGNIFY PRESSURES ACTING TOWARD AND AWAY FROM THE SURFACES, RESPECTIVELY.
- 3. PRESSURES SHOWN ARE APPLIED NORMAL TO THE SURFACE.
- 4. REFER TO PRESSURE ZONE DIAGRAMS PROVIDED FOR CORRESPONDING ZONES.
- 5. ROOF COVERINGS, FINISHES, ETC SHALL BE DESIGNED FOR THE FULL NEGATIVE DESIGN PRESSURE.



DESIGN WIND LOADS - MWFRS

		WA	ALL		ROOF			
	SURFACE 1	SURFACE 1E	SURFACE 4	SURFACE 4E	SURFACE 2	SURFACE 2E	SURFACE 3	SURFACE 3E
LOAD CASE A	35.0	41.2	-26.0	-31.3	24.0	27.9	-27.9	-32.8

	SIDE WALL					ROOF				GABLE	WALL	
WINDWAR		WARD	LEEWARD		WINDWARD		LEEWARD		WINDWARD		LEEWARD	
	SURFACE 1	SURFACE 1E	SURFACE 4	SURFACE 4E	SURFACE 2	SURFACE 2E	SURFACE 3	SURFACE 3E	SURFACE 5	SURFACE 5E	SURFACE 6	SURFACE 6E
LOAD CASE B	-29.8	-31.3	-29.8	-31.3	-41.2	-59.2	-26.0	-33.6	27.5	37.4	-22.3	-28.9

Engineer: Kent Bice
FL License #: 50421
COA# 30468

No 5042
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OR
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1552 6TH ST., WINTER HAVEN, FL 33880 (863)865-6502

WIND	LOAD	TABLES

DATE: 07/13/18 DRAWN BY: RD

SCALE: AS NOTED CHECKED BY: KMB

SHEET:

S-3

SHEET 3 OF 21

F	ASTENING SCHEDULE	
CONNECTION	FASTENING ^{a, k}	LOCATION
1. JOIST TO SILL OR GIRDER	3 - 8d COMMON (2½" X 0.131") 3 - 3" X 0.131" NAILS 3 - 3", 14 GAGE STAPLES	TOENAIL
2. BRIDGING TO JOIST	2 - 8d COMMON (2½" X 0.131") 2 - 3" X 0.131" NAILS 2 - 3", 14 GAGE STAPLES	TOENAIL EACH END
3. SOLE PLATE TO JOIST OR BLOCKING	16d (3½" X 0.135") AT 12" O.C. 3" X 0.131" NAILS AT 12" O.C. 3", 14 GAGE STAPLES AT 12" O.C.	FACE NAIL
4. SOLE PLATE TO JOIST OR BLOCKING AT BRACED WALL PANEL	3 - 16d (3½" X 0.135") AT 16" O.C. 4 - 3" X 0.131" NAILS AT 16" O.C. 4 - 3", 14 GAGE STAPLES AT 16" O.C.	FACE NAIL
5. TOP PLATE TO STUD	2 - 16d (3½" X 0.162") 3 - 3" X 0.131" NAILS 3 - 3", 14 GAGE STAPLES	END NAIL
3. STUD TO SOLE PLATE	4 - 8d COMMON (2½" X 0.131") 4 - 3" X 0.131" NAILS 4 - 3", 14 GAGE STAPLES	TOENAIL
	2 - 16d COMMON (3½" X 0.162") 3 - 3" X 0.131" NAILS 3 - 3", 14 GAGE STAPLES	END NAIL
7. DOUBLE STUDS	16d (3½" X 0.162") AT 24" O.C. 3" X 0.131" NAILS AT 16" O.C. 3", 14 GAGE STAPLES AT 16" O.C.	FACE NAIL
8. TOP PLATE TO TOP PLATE	16d (3½" X 0.162") AT 16" O.C. 3" X 0.131" NAILS AT 12" O.C. 3", 14 GAGE STAPLES AT 12" O.C.	FACE NAIL
	8 - 16d COMMON (3½" X 0.162") 12 - 3" X 0.131" NAILS 12 - 3", 14 GAGE STAPLES	FACE NAIL AT LAP SPLICE
9. BLOCKING BETWEEN JOISTS OR RAFTERS TO TOP PLATE	3 - 8d COMMON (2½" X 0.131") 3 - 3 X 0.131" NAILS 3 - 3", 14 GAGE STAPLES	TOENAIL
10. RIM JOIST TO TOP PLATE	8d (2½" X 0.131") AT 6" O.C. 3" X 0.131" NAILS AT 6" O.C. 3", 14 GAGE STAPLES AT 6" O.C.	TOENAIL
11. TOP PLATES, LAPS AND INTERSECTIONS	2 - 16d COMMON (3½" X 0.162") 3 - 3" X 0.131" NAILS 3 - 3", 14 GAGE STAPLES	FACE NAIL
12. CONTINUOUS HEADER (2) PIECES	16d COMMON (3½" X 0.162")	16" O.C. EACH EDGE, FACE NAIL
13. CEILING JOISTS TO PLATE	3 - 8d COMMON (2½" X 0.131") 3 - 3" X 0.131" NAILS 3 - 3", 14 GAGE STAPLES	TOENAIL
14. CONTINUOUS HEADER TO STUD	4 - 8d COMMON (2½" X 0.131")	TOENAIL
15. RAFTER TO PLATE	3 - 16d (3½" X 0.162") 4 - 3" X 0.131" NAILS 4 - 3", 14 GAGE STAPLES	TOENAIL
16. 1" DIAGONAL BRACE TO EACH STUD AND PLATE	2 - 8d COMMON (2½" X 0.131") 2 - 3" X 0.131" NAILS 3 - 3", 14 GAGE STAPLES	FACE NAIL
17. BUILT-UP CORNER STUDS	16d (3½" X 0.162") 3" X 0.131" NAILS 3" 14 GAGE STAPLES	12" O.C. FACE NAIL

	FASTENIN	G SCHEDULE	
CONNECTION		FASTENING ^{a, k}	LOCATION
18. BUILT-UP GIRDER AND BEAMS	3" X 0.131" NA	N (4" X 0.192") at 32" O.C. AIL AT 24" O.C. TAPLE AT 24" O.C. AND	FACE NAIL AT TOP AND BOTTOM STAGGERED ON OPPOSITE SIDES
	2 - 20d COMM 3 - 3" X 0.131" 3 - 3" 14 GAG		FACE NAIL AT ENDS AND AT EACH SPLICE
19. COLLAR TIE TO RAFTER	3 - 10d COMM 4 - 3" X 0.131" 4 - 3" 14 GAG	_	FACE NAIL
20. ROOF RAFTER TO 2-BY RIDGE BEAM	3 - 10d COMM 4 - 3" X 0.131" 4 - 3" 14 GAG		TOENAIL
21. JOIST TO BAND JOIST	3 - 16d COMM 4 - 3" X 0.131" 4 - 3" 14 GAG		END NAIL
22. WOOD STRUCTURAL PANELS AND PARTICLEBOARD ^b , SUBFLOOR, ROOF AND WALL SHEATHING (TO FRAMING) SINGLE FLOOR, COMBINATION SUBFLOOR-UNDERLAYMENT TO FRAMING	$\frac{1}{2}$ " AND LESS $\frac{19}{32}$ " TO $\frac{3}{4}$ " $\frac{7}{8}$ " TO 1" $\frac{1}{8}$ " TO $\frac{11}{4}$ "	6d ^c , J 2 ³ / ₈ " X 0.113" NAIL ^I 1 ³ / ₄ " X 16 GAGE ^m STAPLE 8d ^d OR 6d ^e 2 ³ / ₈ " X 0.113" NAIL ⁿ 2" 16 GAGE ⁿ STAPLE 8d ^c 10d ^d OR 8d ^e	6" O.C. AT EDGES AND 12" O.C. AT INTERMEDIATE, 4" O.C. AT COMPONENT AND CLADDING EDGE STRIP # ZONE 3 [REFER TO FIGURE ON SHEET S-3]
23. PANEL SIDING TO FRAMING	½" OR LESS 5/8"	6d ^f 8d ^f	6" / 12" O.C. AT EDGES / INTERMEDIATE
24. FIBERBOARD SHEATHING	1/2"	NO. II GAGE ROOFING NAIL ^h 6d COMMON NAIL (2" x 0.113") NO. 16 GAGE STAPLE ⁱ NO. II GAGE ROOFING NAIL ^h 8D COMMON NAIL (2 ½" x 0.131") NO 16 GAGE STAPLE ⁱ	3" / 6" O.C. AT EDGES / INTERMEDIATE FOR STRUCTURAL APPLICATIONS 6" / 12" O.C. AT EDGES / INTERMEDIATE FOR NON-STRUCTURAL APPLICATIONS

- a. COMMON OR BOX NAILS ARE PERMITTED TO BE USED EXCEPT WHERE OTHERWISE STATED.
- b. NAILS SPACED AT 6' O.C. AT EDGES, 12" AT INTERMEDIATE SUPPORTS EXCEPT 6" AT SUPPORTS WHERE SPANS ARE 48" OR MORE. NAILS FOR WALL SHEATHING ARE PERMITTED TO BE COMMON, BOX OR CASING.
- c. COMMON OR DEFORMED SHANK (6d 2" x 0.113"; 8d 2 1/2" x 0.131"; 10d 3" x 0.148").
- d. COMMON (6d 2" x 0.113"; 8d 2 1/2" x 0.131"; 10d x 0.148").
- e. DEFORMED SHANK (6d 2" x 0.113"; 8d 2 1/2" x 0.131"; 10d 3" x 0.148").
- f. CORROSION-RESISTANT SIDING (6d 1 7/8" x 0.106"; 8d 2 3/8' x 0.128") OR CASING (6d 2" x 0.099"; 8d 2 1/2" x 0.113") NAIL.
- g. FASTENERS SPACED 3" O.C. AT EXTERIOR EDGES AND 6" O.C. AT INTERMEDIATE SUPPORTS, WHEN USED AS STRUCTURAL SHEATHING. SPACING SHALL BE 6" O.C. ON THE EDGES AND 12" O.C. AT INTERMEDIATE SUPPORTS FOR NONSTRUCTURAL APPLICATIONS.
- h. CORROSION-RESISTANT ROOFING NAILS WITH 7/16" DIAMETER HEAD AND 1 ½" LENGTH FOR 1/2" SHEATHING AND 1 3/4" LENGTH FOR 25/32" SHEATHING.
- i. CORROSION-RESISTANT STAPLES WITH NOMINAL 7/16" CROWN OR 1" CROWN AND 1 1/4" LENGTH FOR 1/2" SHEATHING AND 1 1/2" LENGTH FOR 25/32" SHEATHING. PANEL SUPPORTS AT 16" (20" IF STRENGTH AXIS IS THE LONG DIRECTION OF THE PANEL, UNLESS OTHERWISE MARKED).
- j. FOR ROOF SHEATHING APPLICATIONS, 8d NAILS (2 1/2" x 0.113") ARE THE MINIMUM REQUIRED FOR WOOD STRUCTURAL PANELS.
- k. STAPLES SHALL HAVE A MINIMUM CROWN WIDTH OF 7/16'.
- I. FOR ROOF SHEATHING APPLICATIONS, FASTENERS SPACED 4" O.C. AT EDGES, 8" O.C. AT INTERMEDIATE SUPPORTS.
- m. FASTENERS SPACED 4" O.C. AT EDGES, 8" O.C. AT INTERMEDIATE SUPPORTS FOR SUBFLOOR AND WALL SHEATHING AND 3" O.C. AT EDGES, 6" AT INTERMEDIATE SUPPORTS FOR ROOF SHEATHING.

n. FASTENERS SPACED 4" O.C. AT EDGES, 8" AT INTERMEDIATE SUPPORTS.

CODE REVIEW
Professional Service Industries, Inc.
An Intertek Company
1748 3376 Street
Orlando, Florida 32839
Plans Reviewer: Richard Olds
ICC #5107840
FL #SMP-45, SMI-76
LSUCCE #U02416
Department Manager: Peter Craig

Engineer: Kent Bice
FL License #: 50421
COA# 30468

No 50421
STATE OF

07/13/18

1552 6TH ST., WINTER HAVEN, FL 33880 (863)865-6502


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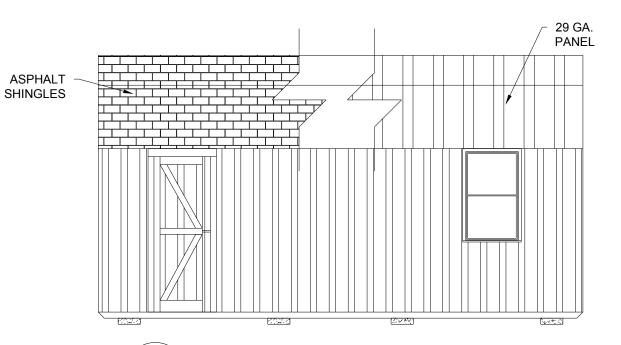
FASTENING SCHEDULE

DATE: 07/13/18 DRAWN BY: RD

SCALE: AS NOTED


SHEET: S-4
SHEET 4 OF 21



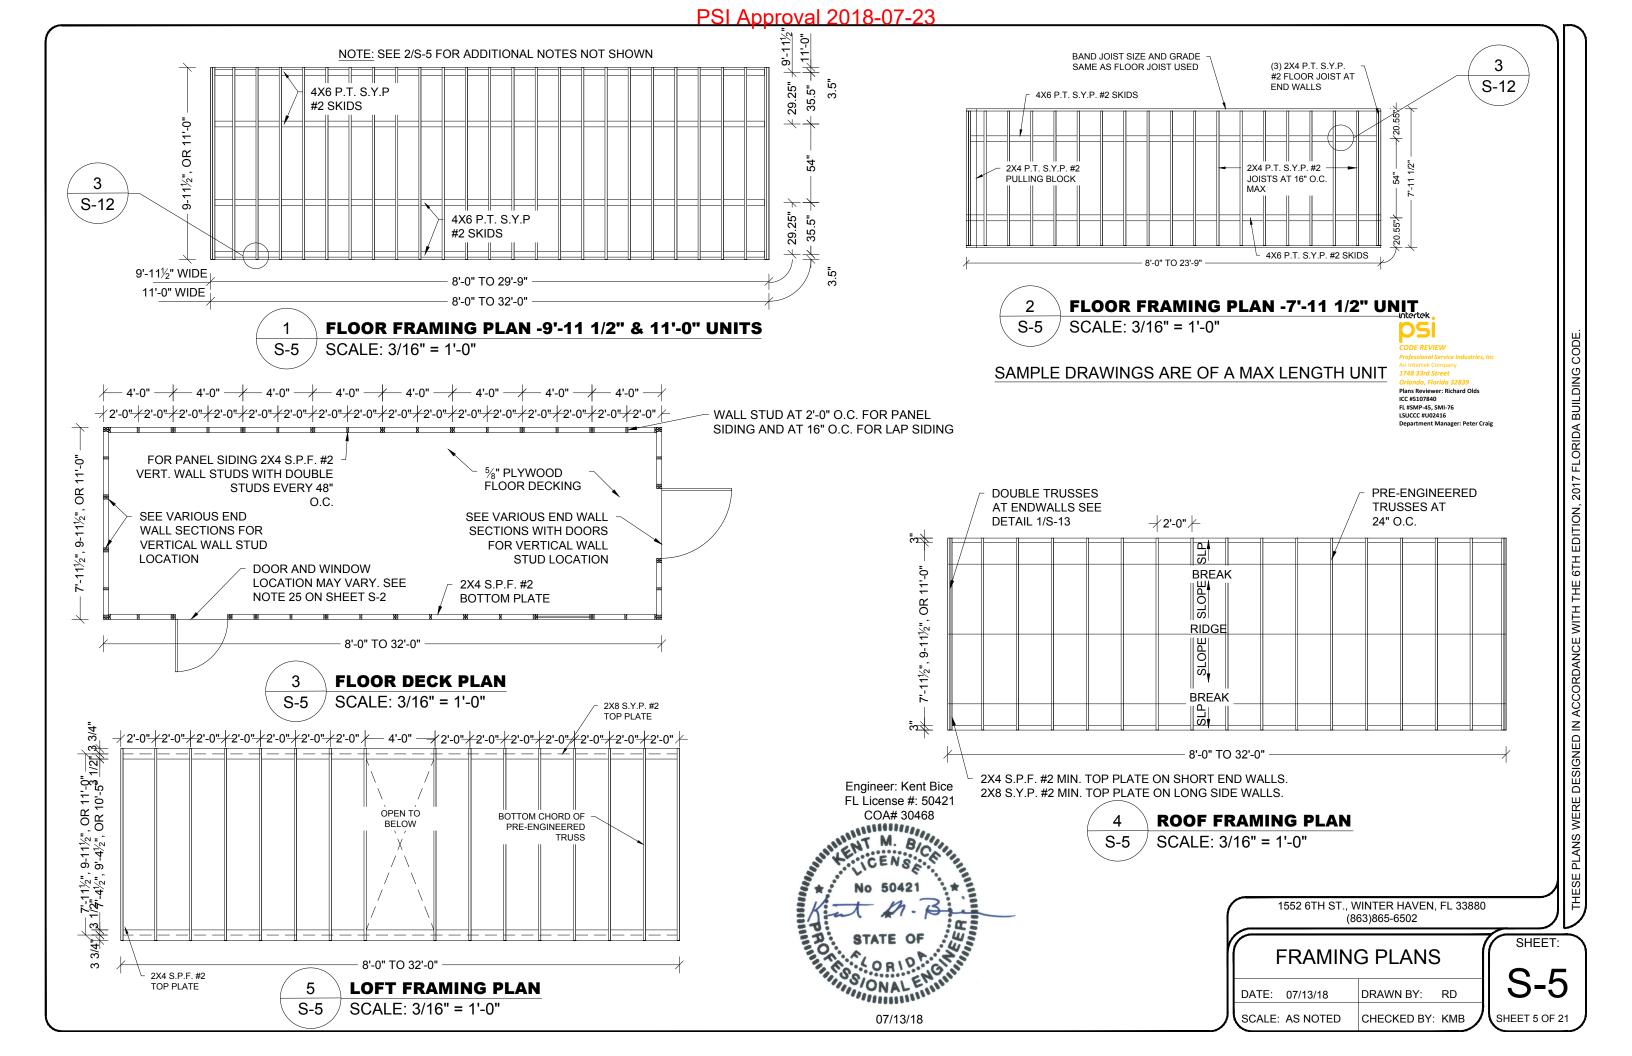


SIDE WALL ELEVATION WITH PANEL SIDING

SCALE: 1/4" = 1'-0"

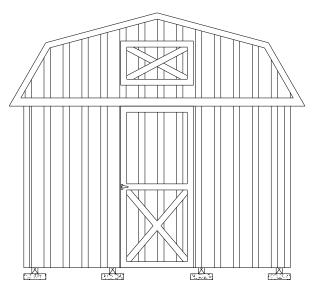



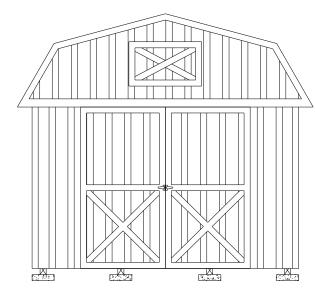

SAMPLE: 11'-0" WIDE UNIT WITH 7'-0" DOOR


ENDWALL ELEVATION WITH PANEL SIDING SCALE: 1/4" = 1'-0"

SHEARWALL WITH 19/32" T1-11¹ OR LP SMARTSIDE STRAND SUBSTRATE PANEL SIDING^{2,3}

FLOOR	OPENI	NG WIDTH	MAX BUILDING LENGTH					
WIDTH (FT)	LONG SIDE WALL	SHORT END WALL	19/32" T1-11 ¹	19/32" LP PANEL ²	19/32" LP PANEL ³			
7'-11½"	2'-0", 3'-0", 4'-0", 6'-0"	2'-0", 3'-0", 4'-0"	23'-9"	23'-9"	23'-9"			
9'-11½"	2'-0", 3'-0", 4'-0", 2'-0", 3'-0", 4'-0", 6'-0"	29'-9"	29'-9"	29'-9"				
_	6'-0", 7'-0"	7'-0"		26'-0"				
11'-0"	2'-0", 3'-0", 4'-0", 2'-0", 3'-0", 4'-0", 6'-0", 7'-0"		32'-0"	32'-0"	32'-0"			
	6'-0", 7'-0", 8'-0"	8'-0"		26'-0"				


NOTES:

- 19/32" T1-11 APA RATED SIDING 303-24 O.C. WITH 8D COMMON OR DEFORMED (0.131"X2-1/2") NAILS AT 6" O.C. IN FIELD AND 3" O.C. IN EDGES.
- 2. 19/32" LP SMARTSIDE STRAND SUBSTRATE PANEL SIDING WITH STAGGERED 8D COMMON OR DEFORMED (0.131"X2-1/2") NAILS AT 6" O.C. IN FIELD AND 3" O.C. IN EDGES.
- 19/32" LP SMARTSIDE STRAND SUBSTRATE PANEL SIDING WITH STAGGERED 8D COMMON OR DEFORMED (0.131"X2-1/2") NAILS AT 6" O.C. IN FIELD AND 2" O.C. IN EDGES.
- WINDOWS AND DOORS MAY BE LOCATED IN EITHER THE SIDE WALL OR ENDWALL. DOORS ARE PERMITTED TO BE IN BOTH ENDWALLS OR ENDWALL AND SIDEWALL IF REQUESTED BY CUSTOMER. LIMITATIONS ON THE TOTAL DIMENSIONS SHALL BE BASED ON THE SHEAR WALL HEIGHT TO WIDTH RATIO OF 3.5:1 AND SHALL NOT EXCEED (2/3) OF THE TOTAL LENGTH OF BUILDING.
- DOOR AND WINDOW SHALL BE LOCATED SUCH THAT THEY ARE AT LEAST 3'3" APART.
- EDGE NAILING SHALL BE PROVIDED AT TOP PLATE IN ALL END WALLS.
- 7. PROVIDE BLOCKING AT ALL UNSUPPORTED EDGES OF WALL SHEATHING.

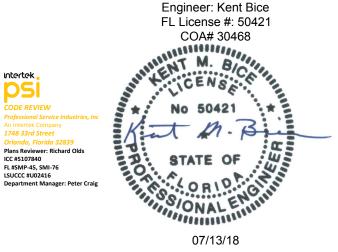

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CHECKED BY: KMB

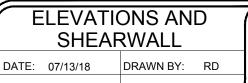

SCALE: AS NOTED

SHEET: SHEET 6 OF 21 intertek

Plans Reviewer: Richard Olds CC #5107840

FL #SMP-45, SMI-76

LSUCCC #U02416

WALL TOP PLATE WALL STUD AT 16" O.C. WALL BOTTOM PLATE **BAND JOIST** 4X6 SKID

(2) SIMPSON CS20 (33MIL X 1-1/4", GRADE 40 STEEL, G60 COATING) X-STRAP OR EQUIVALENT ON INSIDE FACE OF WALL STUD. ATTACH STRAPS TO WALL TOP & BOTTOM PLATES WITH (5) 0.131" x 2-1/4" NAILS STAGGERED. STRAP MAY BE WRAPPED AROUND WALL TOP & BOTTOM PLATES.

ALTERNATE: 7/16" APA RATED SHEATHING ON OUTSIDE FACE OF WALL STUD FASTENED WITH 8d COMMON OR DEFORMED (0.131" x 2-1/2") NAILS AT 6" O.C. IN FIELD AND 3" O.C. AT EDGES.

PARTIAL SIDE WALL FRAMING **ELEVATION WITH LAP SIDING** S-6A SCALE: NTS

SIMPSON CS20 STRAP ON INSIDE WALL STUDS FACE WITH (2) 0.131" X 1-1/2" MIN. NAILS EACH INTO BOTTOM PLATE AND STUD **BAND JOIST** FLOOR SHEATHING **FLOOR JOIST BOTTOM PLATE**

(2) 1/4" x 4" HEX LAG SCREWS WITHIN 3" ON EITHER SIDE OF STUD AT X-BRACE END LOCATIONS AND CENTERED THRU BAND JOIST. PREDRILL MAX. 1/4" DIA. HOLE THRU BOTTOM PLATE AND 0.15" DIA. HOLE THRU SHEATHING AND BAND JOIST.

SAMPLE: 11'-0" WIDE UNIT WITH 3'-0" DOOR

ENDWALL ELEVATION WITH LAP SIDING

SIDE WALL ELEVATION WITH LAP SIDING

SCALE: 1/4" = 1'-0"

S-6A

S-6A

Engineer: Kent Bice

FL License #: 50421

COA# 30468

ONAL MAL

07/13/18

SCALE: 1/4" = 1'-0"

WALL STUD TIEDOWN FOR X-BRACE OPTION S-6A SCALE: NTS

	SHEAF	RWALL WITH LP SMARTSIDE LAP SIDING ¹					
	FLOOR	OPENI	MAX BUILDING LENGTH				
	7'-11½"	LONG SIDE WALL ²	SHORT END WALL ^{3,4}	23'-9"			
		2'-0", 3'-0", 4'-0", 6'-0", 8'-0"	2'-0", 3'-0", 4'-0"				
	9'-11½"	2'-0", 3'-0", 4'-0", 6'-0", 7'-0", 8'-0"	2'-0", 3'-0", 4'-0", 6'-0", 7'-0"	29'-9"			
	11'-0"	2'-0", 3'-0", 4'-0", 6'-0", 7'-0", 8'-0"	2'-0", 3'-0", 4'-0", 6'-0", 7'-0", 8'-0"	32'-0"			

NOTES:

- MIN. 0.45" THICK LP SMARTSIDE 12" BOLD PROFILES DOUBLE 5" FIBER SUBSTRATE LAP SIDING PER ICC-ES ESR 3090, TABLES 2A, 2B AND 2C
- 2. ON LONG SIDE WALL, ATTACH LAP SIDING TO EACH WALL STUD WITH MINIMUM 8d SINKER NAILS (0.113" X 2-3/8") AT 3/8" FROM EACH END, AND 3 NAILS PER STUD -- 3" FROM TOP EDGE, IN THE MIDDLE AND 1-1/2" FROM BOTTOM EDGE. PROVIDE X-STRAP OR SHEATHING ON WALL PER 2/S-6A.
- ON SHORT END WALL, ATTACH LAP SIDING TO SHEATHING WITH MINIMUM 8d SINKER NAILS (0.113" X 2-3/8") AT 3/8" FROM EACH END, AND 3 NAILS PER 16" SPACING -- 3" FROM TOP EDGE, IN THE MIDDLE AND 1-\(\frac{1}{2}\)" FROM BOTTOM EDGE.
- ON SHORT END WALL WITHOUT AN OPENING, PROVIDE MIN. 7/16" APA RATED SHEATHING ON EXTERIOR FACE FASTENED TO STUDS WITH 8d COMMON OR DEFORMED (0.131" x 2-1/2") NAILS AT 6" O.C. IN FIELD AND 4" O.C. AT EDGES. ON SHORT END WALL WITH AN OPENING, PROVIDE 19/32" APA RATED SHEATHING ON EXTERIOR FACE FASTENED TO STUDS WITH 8d COMMON OR DEFORMED (0.131" x 2-1/2") NAILS AT 6" O.C. IN FIELD AND 3" O.C. AT EDGES. ALTERNATE FOR SHORT END WALL WITH OPENING:
 - ON EXTERIOR FACE OF TRUSS PROVIDE PANEL SIDING PER SHEET S-6 ON EXTERIOR FACE OF WALL - PROVIDE LAP SIDING AND ON INTERIOR FACE OF WALL - PROVIDE 19/32" APA RATED SHEATHING.
- WINDOWS AND DOORS MAY BE LOCATED IN EITHER THE SIDE WALL OR ENDWALL. DOORS ARE PERMITTED TO BE IN BOTH ENDWALLS OR ENDWALL AND SIDEWALL IF REQUESTED BY CUSTOMER. LIMITATIONS ON THE TOTAL DIMENSIONS SHALL BE BASED ON THE SHEAR WALL HEIGHT TO WIDTH RATIO OF 3.5:1 AND SHALL NOT EXCEED (2/3) OF THE TOTAL LENGTH OF BUILDING.
- DOOR AND WINDOW SHALL BE LOCATED SUCH THAT THEY ARE AT LEAST 3'-3" APART.
- EDGE NAILING SHALL BE PROVIDED AT TOP PLATE IN ALL END WALLS.
- PROVIDE BLOCKING AT ALL UNSUPPORTED EDGES OF WALL SHEATHING.

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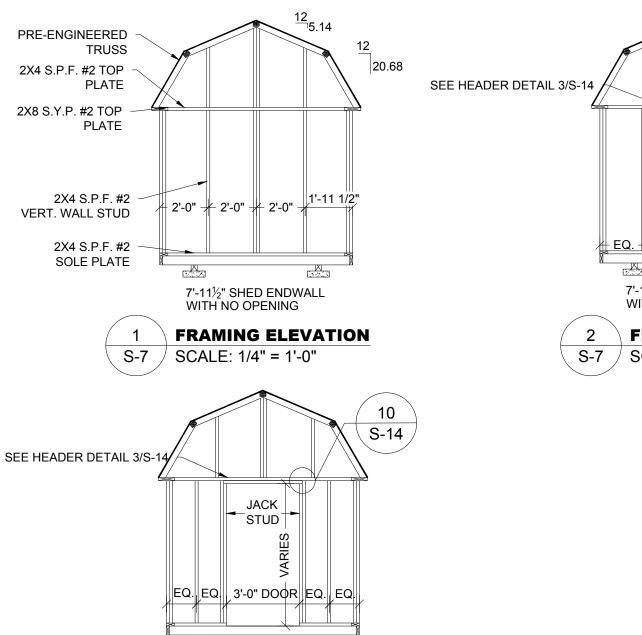
ELEVATIONS AND SHEARWALL

DATE: 07/13/18 DRAWN BY: RD SCALE: AS NOTED CHECKED BY: KMB SHEET 7 OF 21

SHEET:



PSI Approval 2018-07-23




7'-111/2" SHED ENDWALL WITH 3'-0" DOOR OPENING

SCALE: 1/4" = 1'-0"

FRAMING ELEVATION

3

S-7

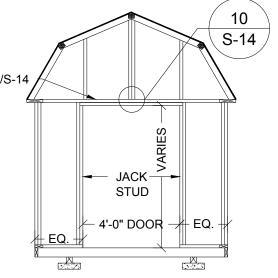

7'-111/2" SHED ENDWALL WITH 4'-0" DOOR OPENING

FRAMING ELEVATION

SCALE: 1/4" = 1'-0"





07/13/18


CHECKED BY: KMB

1552 6TH ST., WINTER HAVEN, FL 33880 (863)865-6502

7'-11 1/2" SHED FRAMING ELEVATIONS					
DATE: 07/13/18	DRAWN BY: RD				


SCALE: AS NOTED

SHEET: SHEET 8 OF 21

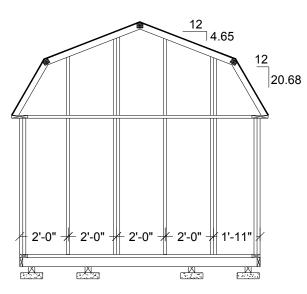

9'-11 $\frac{1}{2}$ " SHED ENDWALL WITH NO OPENING


1 FRAMING ELEVATION
S-8 SCALE: 1/4" = 1'-0"

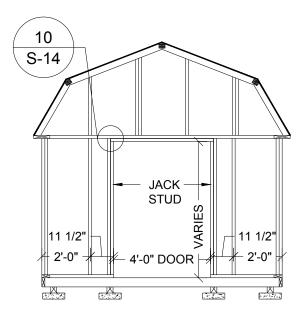

9'-11½" SHED ENDWALL WITH 4'-0" DOOR OPENING


2 FRAMING ELEVATION
S-8 SCALE: 1/4" = 1'-0"



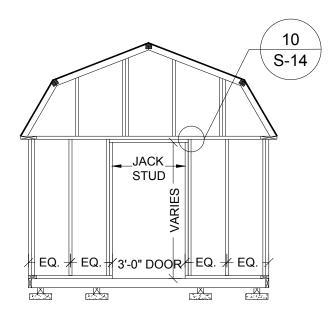


9'-11½" SHED ENDWALL WITH 3'-0" DOOR OPENING

3 FRAMING ELEVATION
S-8 SCALE: 1/4" = 1'-0"

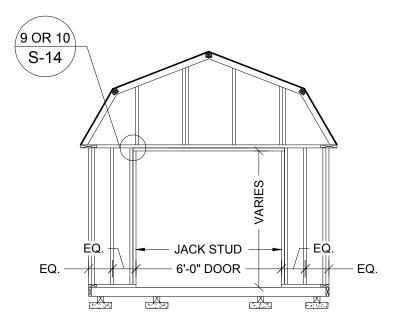

9'-11½" SHED ENDWALL WITH 6'-0" DOOR OPENING

4 FRAMING ELEVATION
S-8 SCALE: 1/4" = 1'-0"

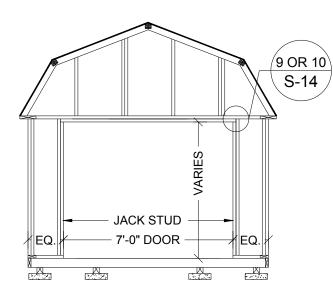

9'-11½" SHED ENDWALL WITH 7'-0" DOOR OPENING

5 FRAMING ELEVATION
S-8 SCALE: 1/4" = 1'-0"

Engineer: Kent Bice
FL License #: 50421
COA# 30468

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STATE OF

07/13/18 1552 6TH ST., WINTER HAVEN, FL 33880

CHECKED BY: KMB

(863)865-6502


9'-11 1/2" SHED FRAMING ELEVATIONS

DATE: 07/13/18 DRAWN BY: RD

SCALE: AS NOTED

SHEET:

S-8
SHEET 9 OF 21

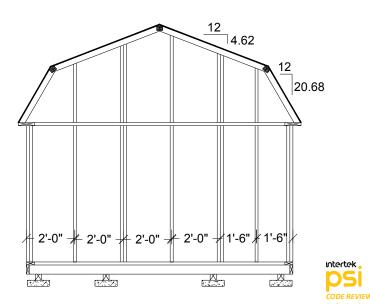

11'-0" SHED ENDWALL WITH NO OPENING

FRAMING ELEVATION

SCALE: 1/4" = 1'-0"

S-9

JACK STUD 2'-0" 1'-6" 4'-0" DOOR 1'-6" 2'-0"

11'-0" SHED ENDWALL WITH 4'-0" DOOR OPENING


2 FRAMING ELEVATION
S-9 SCALE: 1/4" = 1'-0"

Plans Reviewer: Richard Olds ICC #5107840

FL #SMP-45, SMI-76 LSUCCC #U02416 JACK STUD SHAPA JACK STUD SHAPA JACK STUD SHAPA DOOR EQ. EQ.


11'-0" SHED ENDWALL WITH 3'-0" DOOR OPENING

S-9 | SCALE: 1/4" = 1'-0"

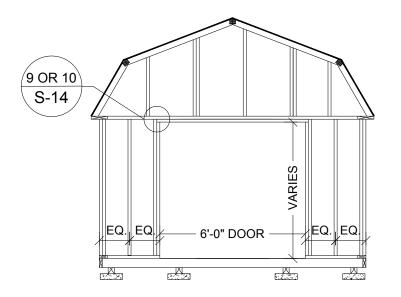


11'-0" SHED ENDWALL WITH 6'-0" DOOR OPENING

S-9 | FRAMING ELEVATION | SCALE: 1/4" = 1'-0"

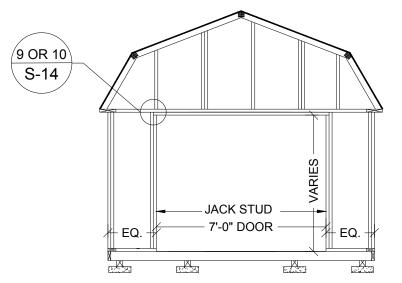

11'-0" SHED ENDWALL WITH 7'-0" DOOR OPENING

5 FRAMING ELEVATION S-9 SCALE: 1/4" = 1'-0"

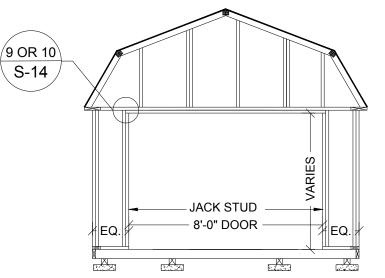

11'-0" SHED ENDWALL WITH 8'-0" DOOR OPENING

6 FRAMING ELEVATION
S-9 SCALE: 1/4" = 1'-0"




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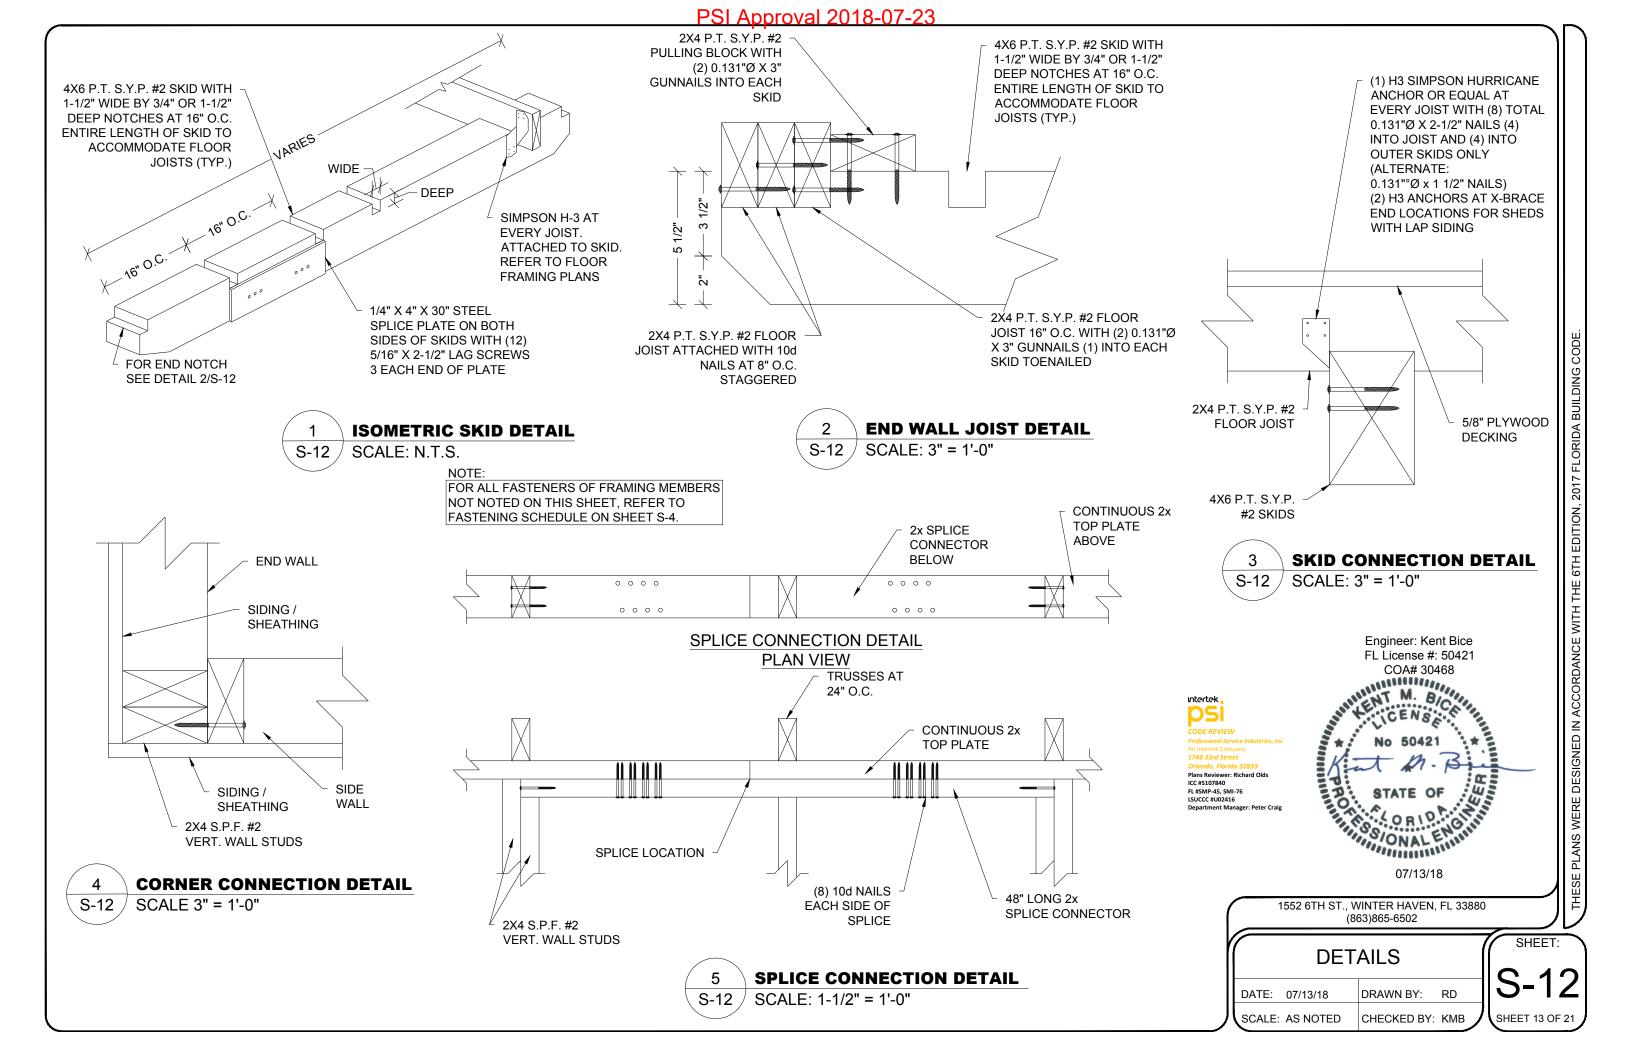
1552 6TH ST., WINTER HAVEN, FL 33880 (863)865-6502

FRA	11'-0" MING E	SHED LEVATIC	NS
DATE:	07/13/18	DRAWN BY:	RD
SCALE:	AS NOTED	CHECKED BY:	кмв


SHEET: S-9
SHEET 10 OF 21

PSI Approval 2018-07-23 PRE-ENGINEERED PRE-ENGINEERED PRE-ENGINEERED DOUBLE TRUSS TRUSSES AT 24" O.C. **TRUSS TRUSS** AT ENDWALL 2X4 S.P.F. #2 WITH S-14 S-14 1/2" FLITCH PLATE SEE DETAIL 4/S-14 (2) 2X4's S.P.F. #2 OR WITH ½" FLITCH PLATE. 2X8 S.Y.P. #2 2X4 S.P.F. #2 SEE DETAIL 3/S-14 TOP PLATE FLATWISE UNDER TOP PLATE PER DETAIL 2X4 S.P.F. #2 2/S-14 FLATWISE UNDER TOP PLATE PER S-14 **CORNER POST** DETAIL 2/S-14 2X4 S.P.F. #2 SEE DETAIL 36" LAID FLAT 4/12 1'-10 1/2" (TYP) 3'-0" **JACK** STUD VARIES SIDEWALL OR ENDWALL 2X4 S.P.F. #2 **SIDEWALL** 2'-0" NOMINAL WINDOW HEADER AND SILL VERT. WALL 3'-0" OPENING HEADER AND SILL **STUD** 2 3 **FRAMING ELEVATION** FRAMING ELEVATION S-10 SCALE: 3/8" = 1'-0" S-10 SCALE: 3/8" = 1'-0" 2X4 S.P.F #2 NOTE: SOLE PLATE - 3'-3" MIN. —/ FOR ALL FASTENING OF FRAMING /— 3'-3" MIN. — MEMBERS NOT NOTED ON THIS 8'-0" TO 32'-0" 4X6 P.T. S.Y.P. SHEET REFER TO FASTENING #2 SKIDS SCHEDULE ON SHEET S-4. FRAMING ELEVATION S-10 SCALE: 3/8" = 1'-0" Engineer: Kent Bice 9 FL License #: 50421 S-14 COA# 30468 intertek (2) 2X4's S.P.F. (2) LAYERS OF 1-3/4" X 3-1/2" #2 WITH ½" S-14 1.9E MICROLLAM LVL BEAM FLITCH PLATE. OR SEE DETAIL 3/S-14 (2) - 2X4 S.P.F. (2) 2X6's S.P.F. #2 JACKSTUDS Plans Reviewer: Richard Old ICC #5107840 #2 WITH ½" FLITCH PLATE FL #SMP-45, SMI-76 LSUCCC #U02416 MINOS/ONAL ENTIN 6'-0" 07/13/18 1552 6TH ST., WINTER HAVEN, FL 33880 **SIDEWALL** (863)865-6502 **SIDEWALL** 4'-0" DOOR OPENING 6'-0" DOOR OPENING SHEET: SIDE WALL ELEVATION FRAMING ELEVATION FRAMING ELEVATION SCALE: 3/8" = 1'-0" S-10 SCALE: 3/8" = 1'-0" S-10 DRAWN BY: RD DATE: 07/13/18 SCALE: AS NOTED CHECKED BY: KMB **SHEET 11 OF 21**




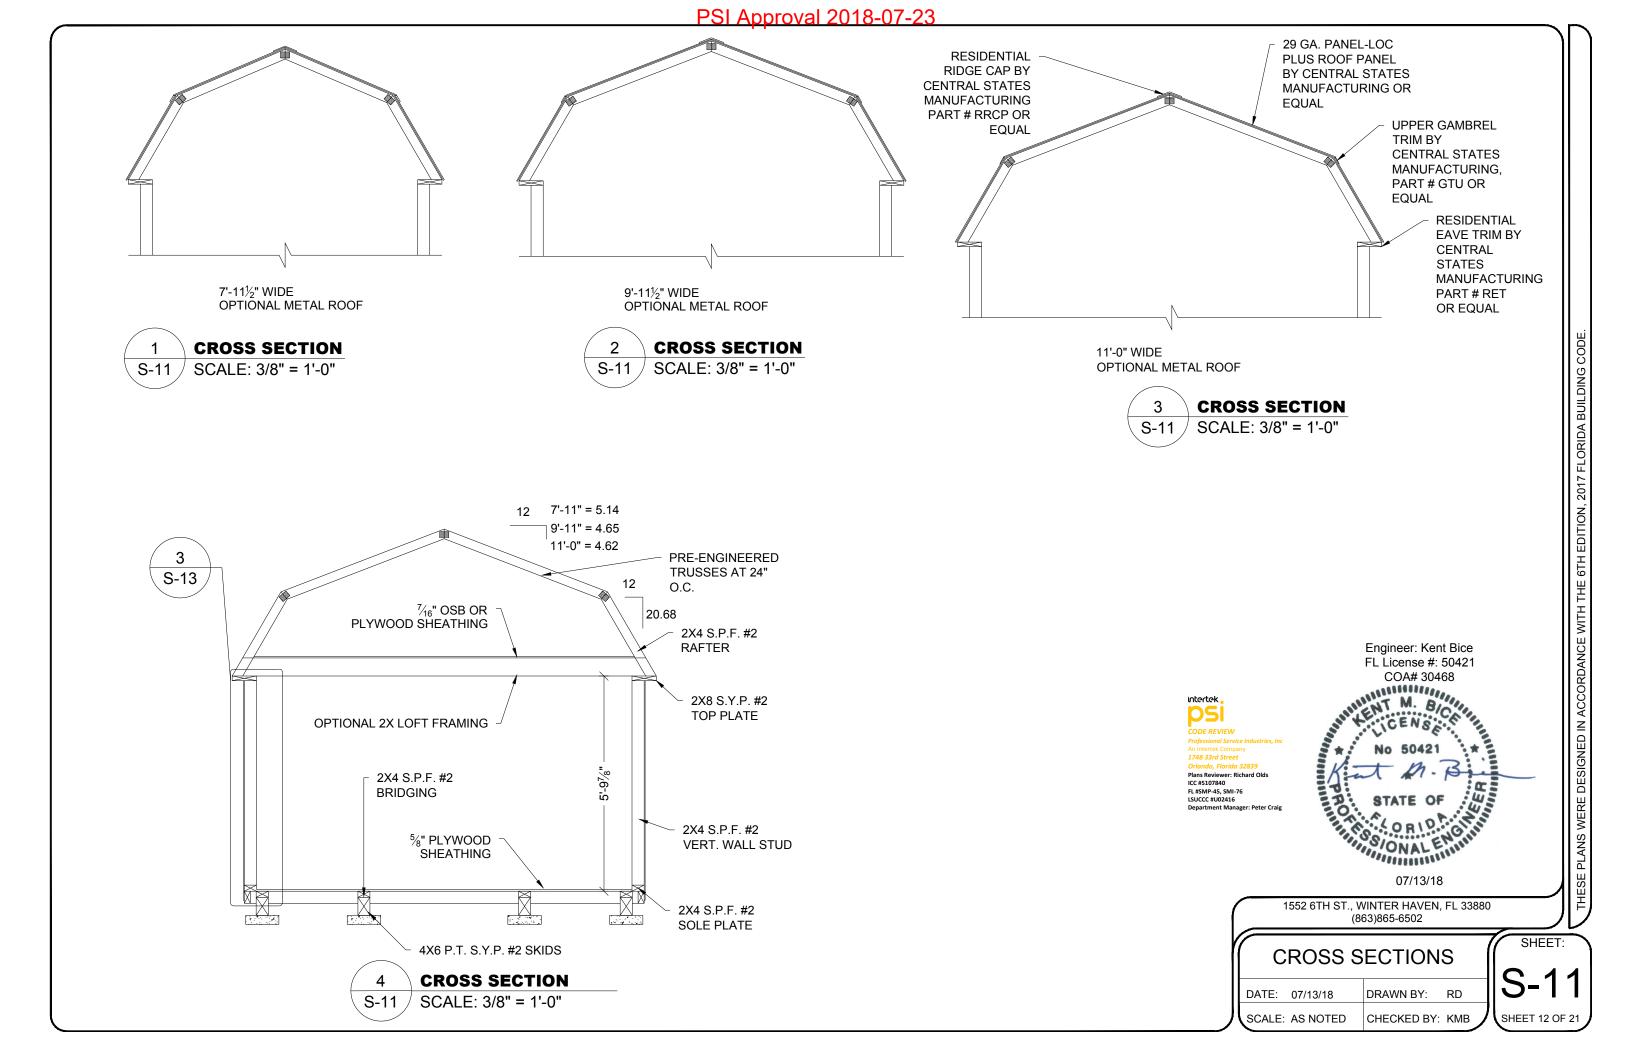

PSI Approval 2018-07-23 ASTM D 7158 CLASS H OR ASTM D DOUBLE PRE-ENGINEERED 3161 CLASS F ASPHALT SHINGLES TRUSSES WITH OVER APPROVED UNDERLAYMENT, NON-CONTINUOUS 1/2" OSB METHOD OR DESIGN AS DESCRIBED SANDWICHED IN BETWEEN **UNDER GENERAL NOTES 10 THRU 13** TRUSSES AT ENDWALLS ON SHEET S-2 ONLY OPTIONAL LOFT FRAMING: 2X4 S.P.F. #2 AT 24" O.C. MAX. 2X8 S.Y.P. #2 TOP FOR 7-11 1/2" & 9'-11 1/2" WIDE SHEDS. SIDING / SHEATHING PLATE NOTCHED TO 2X6 S.P.F. #2 AT 24" O.C. MAX. **RECEIVE SIDING** FOR 11'-0" WIDE SHED. 7/16" OSB OR PLYWOOD ATTACH TO TRUSS WITH (5) 2X4 S.P.F. #2 SHEATHING FASTENED WITH 0.131" Ø X 3" NAILS AT EACH END WALL STUD 2-3/8" x 0.113" NAILS AT 6" O.C. IN FIELD AND EDGES SIMPSON CS20 20 GA. X 1-1/4" GALV. STEEL STRAP SIMPSON LTS12 WITH **DOUBLE TRUSS DETAIL** 0.131"Ø X 3" GUNNAIL WITH (18) 0.131"Ø X 2-1/4" TOENAILED RAFTER (12) TOTAL (6) EACH NAILS OR EQUAL (9) INTO SCALE: 1-1/2" = 1'-0" **END OR SIMPSON H8** TO TOP PLATE RAFTERS AND (9) INTO WITH (8) TOTAL (4) STUD WALL **EACH END** 0.148"Ø X 1-1/2" **GUNNAILS OR EQUAL ALTERNATE WALL** INTO RAFTERS AND SIDING / SHEATHING, STUD TO RAFTER DETAIL 29 GA. PANEL-LOC PLUS SEE SHEETS S-6 AND S-6A STUD WALLS / TOP PLATE. S-13 SCALE: 1-1/2" = 1'-0" ROOF PANEL BY CENTRAL STRAP MAY BE BENT AROUND STATES MANUFACTURING TOP PLATE IF WALL STUDS ARE OR EQUAL AT 16" O.C. ALTERNATE: 0.131" X 1-\frac{1}{2}" NAILS. ATTACH PANEL TO SHEATHING WITH #10 KWIKSEAL II WOODBINDER SCREWS WITH SEALING WASHER OR APPROVED EQUAL AT MAX. 24" O.C. ALONG THE SLOPE AND 6"-3"-6" ACROSS Plans Reviewer: Richard Old: ICC #5107840 FL #SMP-45, SMI-76 THE PANEL AT ALL LOCATIONS LSUCCC #U02416 2X4 FLOOR JOIST 2X4 S.P.F. #2 VERT. Engineer: Kent Bice WALL STUD 24" O.C. SIMPSON CS20 20 GA. X 2X4 BAND FL License #: 50421 1-1/4" GALV. STEEL STRAP COA# 30468 WITH (18) 0.131"Ø X 2-1/4" M DIVI NAILS OR EQUAL (9) INTO 7/16" OSB OR PLYWOOD **WALL STUD TO RAFTER** RAFTERS AND (9) INTO SHEATHING FASTENED WITH AND FLOOR FASTENING DETAIL STUD WALL 2-3/8" x 0.113" NAILS AT 6" O.C. IN FIELD AND EDGES S-13 SCALE: 1-1/2" = 1'-0" **ALTERNATE WALL STUD TO RAFTER WITH METAL ROOF DETAIL** NOTE: SCALE: 1-1/2" = 1'-0" S-13 FOR ALL FASTENING OF FRAMING MEMBERS NOT NOTED ON THIS SHEET. REFER TO WOONAL ELLI **FASTENING SCHEDULE ON SHEET S-4.** 07/13/18 1552 6TH ST., WINTER HAVEN, FL 33880 (863)865-6502 SHEET: **DETAILS WALL STUD TO RAFTER FASTENING WITH METAL ROOF DETAIL** S-13 SCALE: 1-1/2" = 1'-0" DATE: 07/13/18 DRAWN BY: RD SCALE: AS NOTED CHECKED BY: KMB SHEET 14 OF 21

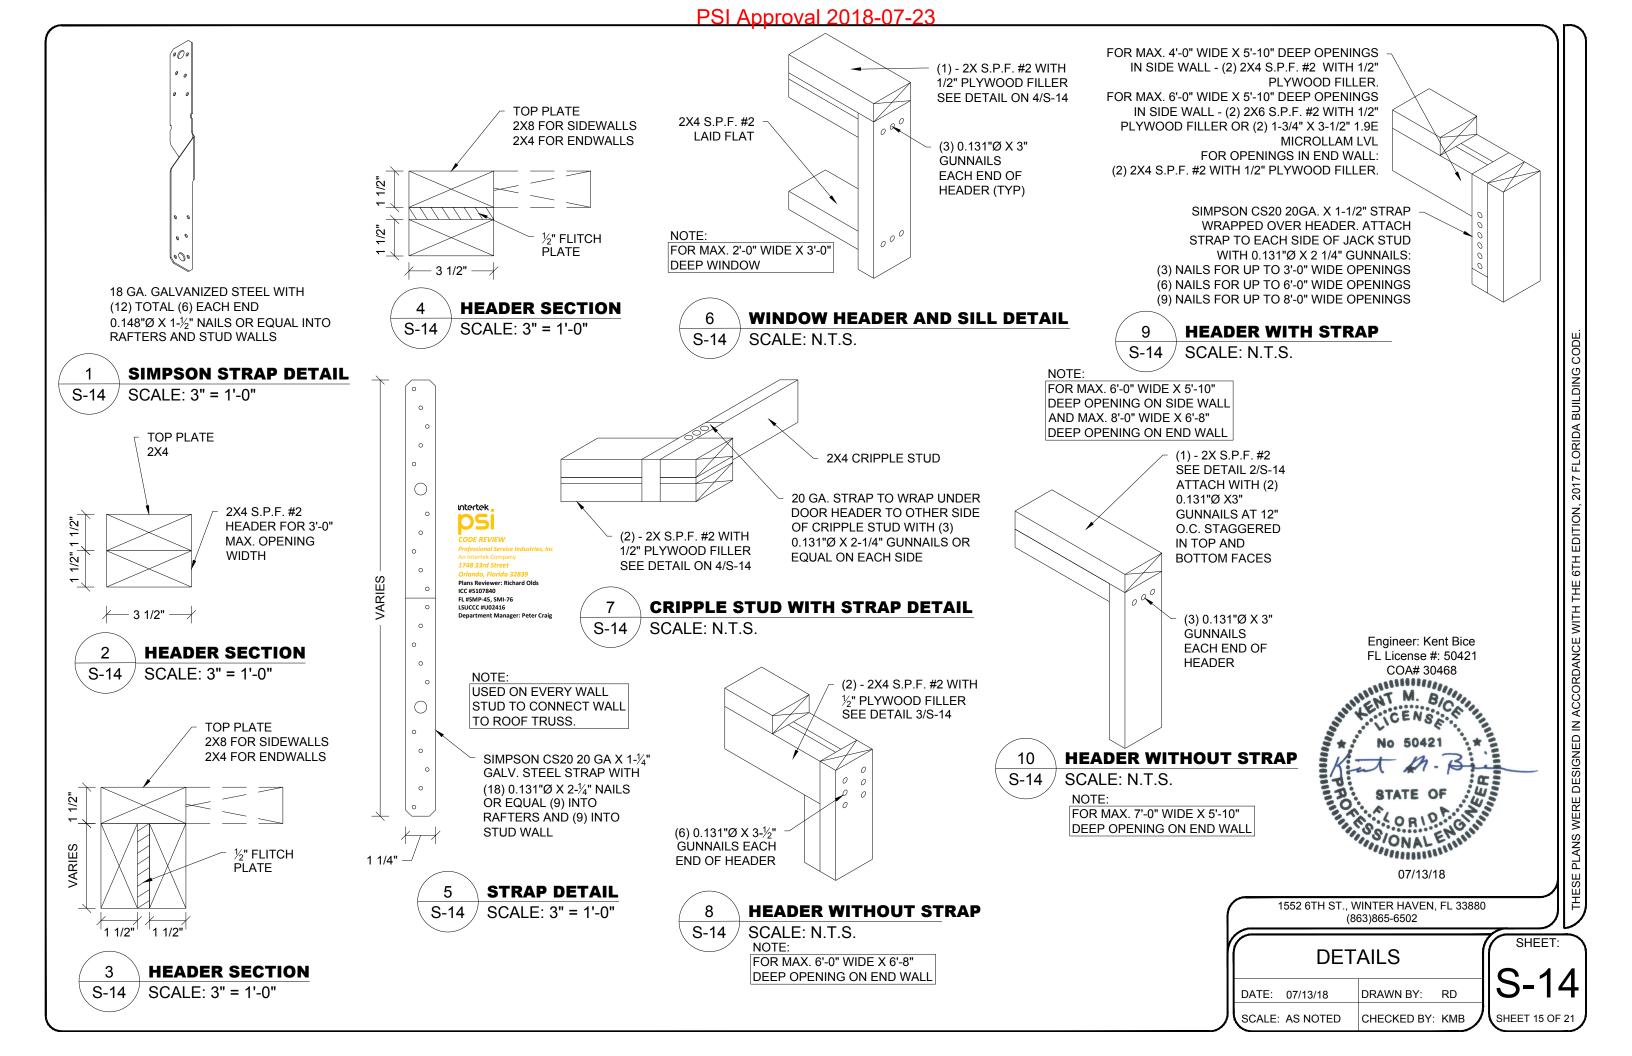


PSI Approval 2018-07-23 $\longleftarrow \frac{\text{4'-0"}}{\text{OPT. 6'-0"}} \longrightarrow \longleftarrow$ 9'-11½", OR 11'-0" FLOOR SKID 2X FLOOR JOIST SEE SHEET S-5 FOR DECKING SUPPORT 7'-111/2", **DOUBLE 2X JOISTS FLOOR JOISTS** 2 AT WALL TO PORCH SEE SHEET S-5 S-20 12'-0" MIN. LENGTH -**OPTIONAL STRAIGHT PORCH FLOOR FRAMING PLAN** S-15 SCALE: 1/4" = 1'-0" S-20 12'-0" MIN. OVERALL LENGTH S-20 5/4" X 6" S.Y.P. STD. P.T. FLOOR DECKING WALL STUD SEE SHEET S-5 OPTIONAL 42" Engineer: Kent Bice FL License #: 50421 HIGH GUARDRAIL FLOOR DECK COA# 30468 S-19 SEE SHEET S-5 A THE PARTY OF THE intertek P.T. 4X6 S.Y.P. #2 POST AT 6'-0" MAX. **SPACING** 4X4 S.P.F. #2 POST OR OPTIONAL POST (2) 2X4 S.P.F. #2 WITH WITH GUARDRAIL 1/2" FLITCH PLATE Plans Reviewer: Richard Olds ICC #5107840 FL #SMP-45, SMI-76 LSUCCC #U02416 P.T. 4X6 S.Y.P. #2 POST ON SIDE WALL FOR 4' PORCH - EXTEND TOP PLATE TO NOTES: TOP OF POST WITH P.T. 2X4 S.Y.P #2 BEAM UNDER IT. 07/13/18 ON SIDE WALL FOR 6' PORCH - (2) 1-3/4" X 3-1/2" 1.9E 1. P.T. 4X6 S.Y.P. #2 POST 1552 6TH ST., WINTER HAVEN, FL 33880 MICROLLAM LVL BEAM OR P.T. (2) 2X6 S.P.F. #2 WITH IS SHOWN. 4X4 POST IS (863)865-6502 1/2" FLITCH PLATE BETWEEN THE PLIES **OPTIONAL** SHEET: FRAMING & FLOOR PLAN **OPTIONAL STRAIGHT** FOR STRAIGHT PORCH **PORCH FLOOR PLAN** S-15 SCALE: 1/4" = 1'-0" DRAWN BY: RD DATE: 07/13/18 SCALE: AS NOTED CHECKED BY: KMB SHEET 16 OF 21

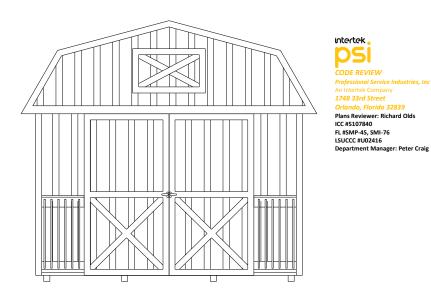

ENDWALL WITH OPTIONAL STRAIGHT PORCH ELEVATION

S-16 | SCALE: 1/4" = 1'-0"

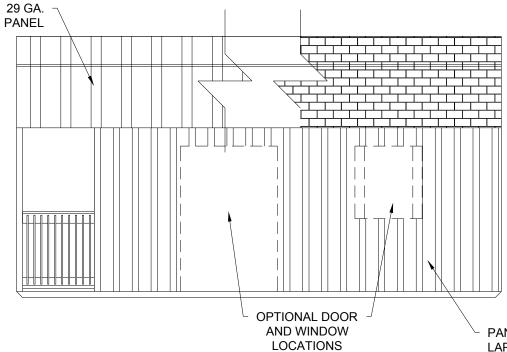

PANEL SIDING SHOWN.
LAP SIDING OPTIONAL.
SEE SHEET S-6A

2

SIDEWALL WITH OPTIONAL STRAIGHT PORCH ELEVATION

SCALE: 1/4" = 1'-0"

Engineer: Kent Bice
FL License #: 50421
COA# 30468

No 50421
STATE OF

07/13/18

1552 6TH ST., WINTER HAVEN, FL 33880 (863)865-6502

ELEVATIONS FOR STRAIGHT PORCH


DATE: 07/13/18 DRAWN BY: RD

SCALE: AS NOTED CHECKED BY: KMB

S-16
SHEET 17 OF 21

SHEET:

PSI Approval 2018-07-23 24'-0" MIN. LENGTH FOR 4'-0" PORCH; 26'-0" MIN. LENGTH FOR 6'-0" PORCH (2) 2X4 FLOOR JOISTS OPT. 6'-0" S.Y.P. #2 AT WALL TO PORCH FLOOR SKID SEE SHEET S-5 -0" MAX. **FLOOR JOIST** 6'-0" MAX. 5 4 SEE SHEET S-5 S-20 S-20 10'-10" STANDARD S-20 12'-10" WITH OPTIONAL 6'-0" PORCH ON SIDE WALL FOR 4' PORCH - EXTEND TOP PLATE TO **OPTIONAL CLIPPED PORCH** TOP OF POST WITH P.T. 2X4 S.Y.P #2 BEAM UNDER IT. **FLOOR FRAMING PLAN** ON SIDE WALL FOR 6' PORCH - (2) 1-3/4" X 3-1/2" 1.9E S-17 SCALE: 1/4" = 1'-0" MICROLLAM LVL BEAM OR P.T. (2) 2X6 S.P.F. #2 WITH 1/2" FLITCH PLATE BETWEEN THE PLIES S-19 4X4 S.P.F. #2 POST OR (2) 2X4 S.P.F. #2 WITH 1/2" FLITCH PLATE OPTIONAL 42" HIGH GUARDRAIL Engineer: Kent Bice FL License #: 50421 5/4" X 6" S.Y.P. STD. P.T. FLOOR DECKING COA# 30468 A STATE OF THE PARTY OF THE PAR intertek P.T. 4X6 POST 4X4 S.P.F. #2 POST OR SEE NOTES BELOW (2) 2X4 S.P.F. #2 WITH DOUBLE 2X4 VERTICAL 1/2" FLITCH PLATE STUDS AT ALL OPENING LOCATIONS Plans Reviewer: Richard Olds ICC #5107840 FL #SMP-45, SMI-76 LSUCCC #U02416 ORI STATE 4'-0" — 3 WALL STUD NOTES: S-20 SEE SHEET S-5 10'-10" STANDARD 12'-10" WITH OPTIONAL 6'-0" PORCH 1. ADDITIONAL POSTS MAY BE ADDED ABOVE AND BEYOND THE AMOUNT SHOWN 07/13/18 PROVIDED THE SPACING DOES NOT EXCEED 6'-0" O.C. 1552 6TH ST., WINTER HAVEN, FL 33880 (863)865-6502 2. P.T. 4X6 S.Y.P. #2 POST IS SHOWN 4X4 POST IS OPTIONAL. SHEET: FRAMING & FLOOR PLAN **OPTIONAL CLIPPED** FOR CLIPPED PORCH **PORCH FLOOR PLAN** DRAWN BY: RD DATE: 07/13/18 SCALE: 1/4" = 1'-0" SCALE: AS NOTED CHECKED BY: KMB **SHEET 18 OF 21** PSI Approval 2018-07-23

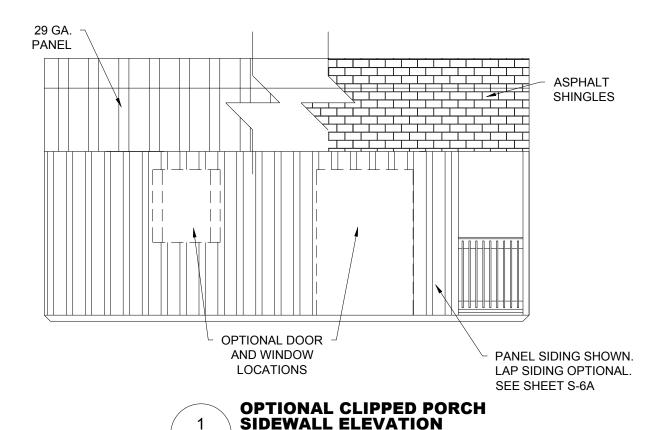


SCALE: 1/4" = 1'-0"


S-18

29 GA. **PANEL ASPHALT SHINGLES OPTIONAL** WINDOW

OPTIONAL CLIPPED PORCH SIDEWALL ELEVATION

SCALE: 1/4" = 1'-0"

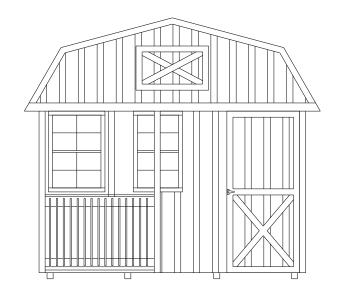

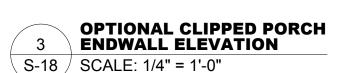

intertek Plans Reviewer: Richard Olds ICC #5107840 FL #SMP-45, SMI-76 LSUCCC #U02416



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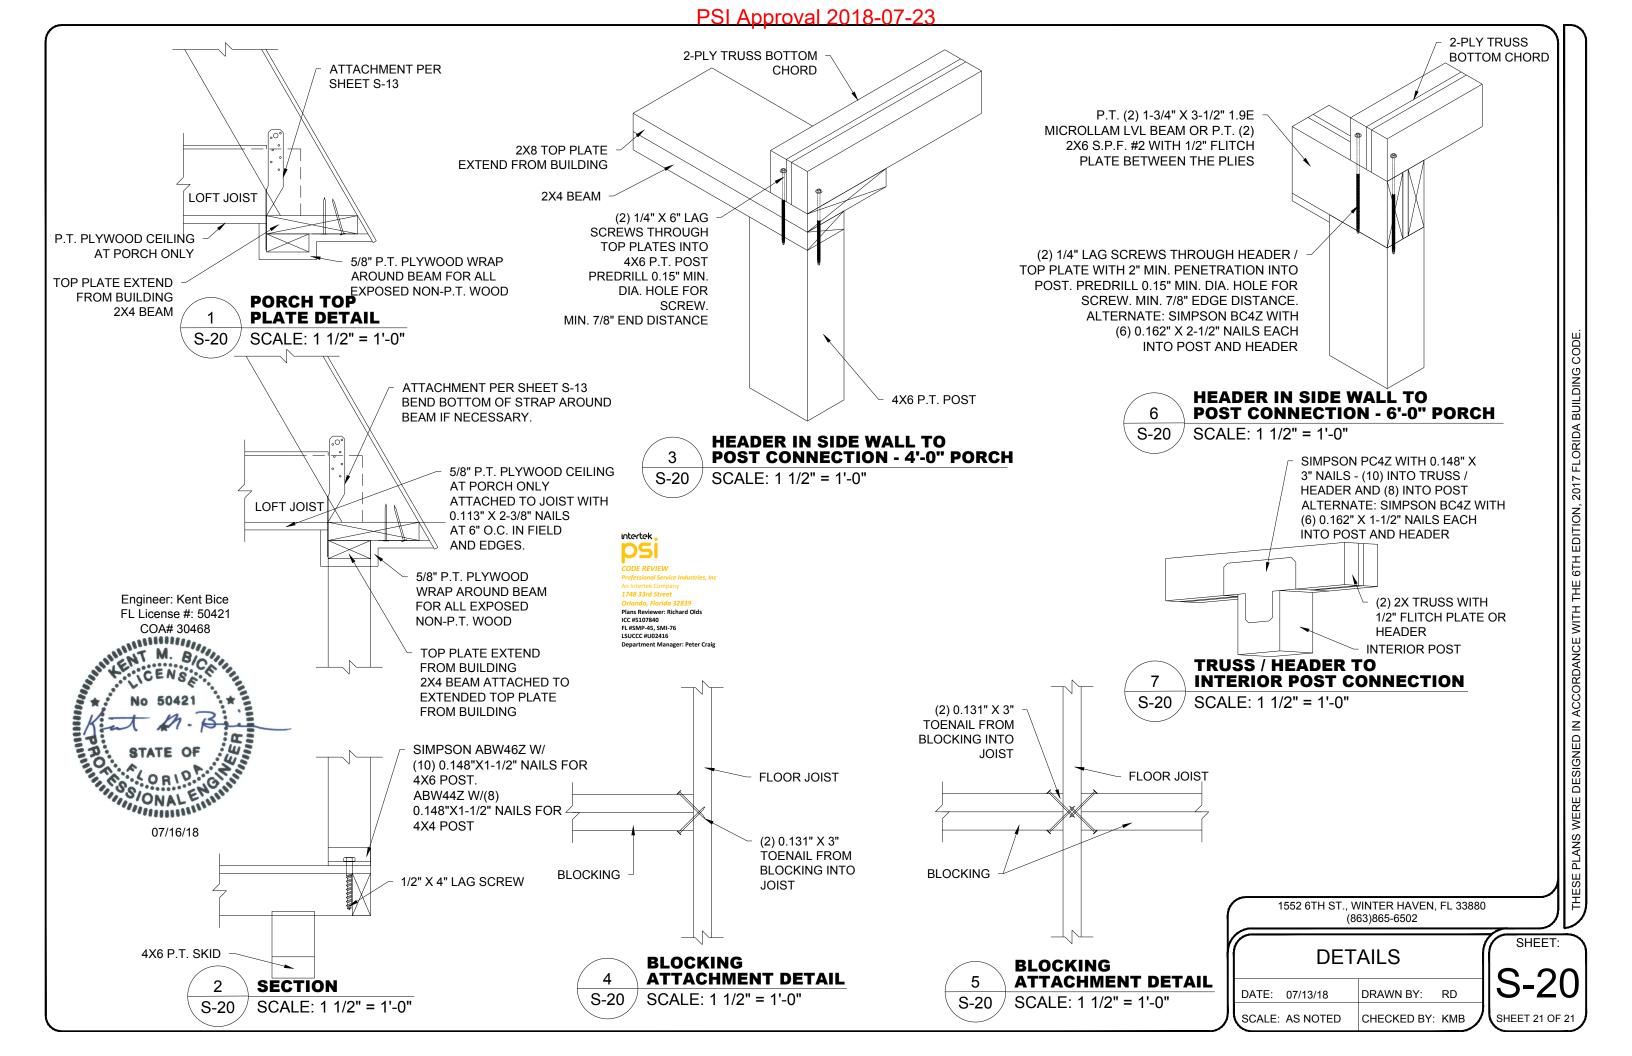
CHECKED BY: KMB

ELEVATIONS FOR CLIPPED PORCH DATE: 07/13/18 DRAWN BY: RD

SCALE: AS NOTED

SHEET 19 OF 21

SHEET:



COOK PORTABLE WAREHOUSES

100 DOUGLAS ST. VALDOSTA, GA 31601 132 CENTRAL INDUSTRIAL ROW, PURVIS, MS 39475 1398 HWY 95 NORTH, BASTROP, TX 78602

TIEDOWN PLANS

STATE OF FLORIDA

GENERAL NOTES

- 1. THE CONTRACTOR SHALL BE RESPONSIBLE FOR VERIFYING ALL EXISTING CONDITIONS.
- 2. THE CONTRACTOR SHALL BE RESPONSIBLE FOR COORDINATING ARCHITECTURAL, STRUCTURAL, MECHANICAL, AND ELECTRICAL DETAIL AND DIMENSIONS. ANY DISCREPANCIES BETWEEN SUCH DETAILS AND DIMENSIONS SHALL BE REPORTED TO THE ENGINEER PRIOR TO PROCEEDING WITH THE WORK.
- 3. THE CONTRACTOR SHALL BE RESPONSIBLE FOR ERECTION PROCEDURE AND SEQUENCE TO INSURE THE INTEGRITY OF THE BUILDING AND ITS COMPONENT PARTS DURINGCONSTRUCTION.
- 4. THESE PLANS HAVE BEEN PREPARED PER REGULATIONS OF THE 6TH EDITION, 2017 FLORIDA BUILDING CODE. THE WORK OF ALL CONTRACTORS SHALL COMPLY WITH THE REQUIREMENTS SET FORTH IN THE AFOREMENTIONED CODE. NO DEVIATIONS FROM THE WORK SHOWN OR REASONABLY IMPLIED SHALL BE UNDERTAKEN WITHOUT THE ENGINEERS WRITTEN CONSENT A COPY OF WHICH WILL BE FILED WITH THE CONSTRUCTION OFFICIAL.
- ANY CHANGES TO OR DEVIATIONS FROM THESE DRAWINGS SHALL NOT BE MADE WITHOUT WRITTEN CONSENT FROM THE ENGINEER.
- 6. THESE DRAWINGS ARE THE PROPERTY OF THE ENGINEER AND SHALL NOT BE USED WITHOUT HIS CONSENT. DRAWINGS SHALL NOT BE USED FOR ISSUE OF BUILDING PERMIT UNLESS SIGNED AND SEALED BY THE ENGINEER.
- 7. THE OWNER AND THE CONTRACTOR SHALL HOLD HARMLESS THE ENGINEER FROM AND AGAINST ALL LIABILITY CLAIMS, DAMAGES, LOSSES, AND EXPENSES INCLUDING LEGAL FEES ARISING OUT OF OR RESULTING FROM ERRORS OR OMISSIONS IN THE PERFORMANCE OF THE WORK BY THE CONTRACTOR. THE DRAWINGS SHOW THE GENERAL ARRANGEMENTS AND EXTENT OF THE WORK. AS THE WORK PROGRESSES, THE OWNER AND THE CONTRACTOR, AT NO EXTRA COSTS, SHALL MAKE THE MODIFICATIONS TO MAKE THE PARTS ALIGN.
- 8. ALL WORK AND MATERIALS SHALL MEET THE REQUIREMENTS OF LOCAL AND STATE CODES AND THE SPECS OF THE NATIONAL BOARD OF FIRE UNDERWRITERS. CONTRACTORS SHALL CHECK AND VERIFY ALL PLAN DIMENSIONS AND CONDITIONS BEFORE PROCEEDING WITH CONSTRUCTION. HE SHALL REPORT ANY DISCREPANCIES TO THE ENGINEER FOR CORRECTION PRIOR TO BEGINNING ANY WORK. THE DISCOVERY OF DISCREPANCIES AFTER THE BEGINNING OF WORK WILL BE EVIDENCE OF FAULTY WORK. AND SHALL BE THE RESPONSIBILITY OF THE CONTRACTOR. DO NOT SCALE DRAWINGS. ALL WRITTEN DIMENSIONS GOVERN.
- 9. THE CONTRACTOR FOR THIS PROJECT SHALL INCLUDE ALL MATERIALS AND LABOR REQUIRED TO COMPLETE THE TOTAL PROJECT. THE CONTRACTOR SHALL FURNISH AND PAY FOR ALL MATERIALS. TOOLS, EQUIPMENT, LABOR, MACHINERY, TRANSPORTATION, HEAT, WATER, UTILITIES, AND ALL OTHER FACILITIES AND SERVICES REQUIRED FOR THE SAFE AND PROPER EXECUTION AND COMPLETION OF THE WORK.
- 10. THE DOCUMENTS SHOW AN OVERVIEW OF THE WORK REQUIRED UNDER THIS CONTRACT AND RELATED REQUIREMENTS AND CONDITIONS THAT WILL IMPACT THE PROJECT. ALL DRAWINGS ARE COMPLIMENTARY. THE DRAWINGS GENERALLY SHOW THE INTENT OF THE OVERALL COMPLEXITY AND CONCEPTS OF THE PROJECT, AND DO NOT NECESSARILY SHOW ALL DETAILS AND CONDITIONS. ALL NEW INTERIOR CONCRETE SLABS AND FOUNDATION WALLS AND FOOTINGS SHALL HAVE SOIL POISONING UNDER NEW WORK AND SHALL BE INSTALLED BY A LICENSED CONTRACTOR.
- 11. ALL WORK SHALL BE COMPLETED IN ACCORDANCE WITH ALL STATE AND DEPARTMENT OF AGRICULTURE, STRUCTURAL PEST CONTROL DIVISION REGULATIONS, RULES DEFINITIONS AND REQUIREMENTS.
- 12. THE CONTRACTOR SHALL BE RESPONSIBLE FOR VERIFYING AND MAINTAINING ALL EXISTING SETBACKS, EASEMENTS, AND ANY DEED RESTRICTIONS.
- 13. THE CONTRACTOR SHALL BE RESPONSIBLE FOR FINAL CLEANUP AND SHALL INCLUDE THE SITE, AND THE BUILDING. THE ENTIRE PROJECT SHALL BE LEFT IN A NEW, CLEAN CONDITION.
- 14. TIEDOWNS SHOWN INCLUDING STRAP AND ANCHOR, AND BEARING PADS ARE BASED ON AN ALLOWABLE BEARING PRESSURE OF 2500 PSF. ANY SOIL CONDITIONS THAT MAY DIFFER FROM THIS MUST BE BROUGHT TO THE ATTENTION OF THE ENGINEER.
- 15. THE CONTRACTOR IS RECOMMENDED TO USE A SOIL TEST PROBE TO DETERMINE THE SOIL CLASS. WHERE SUCH TESTING IS NOT CONDUCTED, IT IS RECOMMENDED TO USE A 60" GALVANIZED ANCHOR WITH STABILIZER PLATE.
- 16. CONCRETE PADS UNDER SKIDS ARE OPTIONAL AND SHALL BE LOCATED ON UNDISTURBED SOIL OR PROPERLY COMPACTED FILL MATERIAL. COMPACTED SOIL SHALL BE TESTED TO A MINIMUM OF 95% PROCTOR IN ACCORDANCE WITH ASTM D1557. FILL MATERIAL SHALL BE FREE OF VEGETATION AND FOREIGN MATERIAL.
- 17. FINISH GRADE SHALL BE SLOPED AWAY FROM THE FOUNDATION FOR DRAINAGE. PROVISIONS SHALL BE MADE TO PREVENT SOIL EROSION UNDER THE PAD AND DIRECT WATER AWAY FROM IT.

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SHEET NUMBER	SHEET TITLE										
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1552 6TH ST., WINTER HAVEN, FL 33880 (863)865-6502

GENERAL NOTES

DATE: 04/10/18 DRAWN BY: RD

SCALE: AS NOTED CHECKED BY: KMB

SHEET:

F-1

SHEET 1 OF 6

TIEDOWN SCHEDULE FOR 111 TO 130 MPH WIND SPEED, EXPOSURE "B"												"B"	
BLDG NUMBER OF TIEDOWNS PER OUTER SKID BY BUILDING LENGTH (FT)										T)			
WIDTH	8'-0"	10'-0"	12'-0"	14'-0"	16'-0"	18'-0"	20'-0"	22'-0"	24'-0	26'-0"	28'-0"	30'-0"	32'-0"
6'-0"	2	2	2	N/A	N/A	N/A	N/A	N/A	N/A	N/A	N/A	N/A	N/A
7'-11" 1/2"	2	2	2	2	2	2	2	2	2	N.A.	N.A.	N.A.	N.A.
9'-11" 1/2"	2	2	2	2	2	2	2	2	2	2	2	2	N.A.
11'-0"	2	2	2	2	2	2	2	2	2	2	2	2	2

TIEDOWN SCHEDULE FOR 131 TO 160 MPH WIND SPEED, EXPOSURE "B"													
BLDG	1	NUMBE	ER OF	TIEDO	OWNS	PER (OUTEF	R SKID	BY BU	ILDING	S LENG	STH (F	T)
WIDTH	8'-0"	10'-0"	12'-0"	14'-0"	16'-0"	18'-0"	20'-0"	22'-0"	24'-0	26'-0"	28'-0"	30'-0"	32'-0"
6'-0"	2	2	2	N/A	N/A	N/A	N/A	N/A	N/A	N/A	N/A	N/A	N/A
7'-11" 1/2"	2	2	2	2	2	2	3	3	3	N.A.	N.A.	N.A.	N.A.
9'-11" 1/2"	2	2	2	2	2	2	2	3	3	3	3	3	N.A.
11'-0"	2	2	2	2	2	2	2	3	3	3	3	3	4

- 1. PROVIDE A MINIMUM OF ONE TIEDOWN STRAP AND ANCHOR AT EACH END OF EACH OUTER SKID. EVENLY SPACE THE REMAINING TIEDOWNS.
- 2. WRAP THE STRAP AROUND THE SKID AND ATTACH TO ANCHOR.
- 3. MAXIMUM PERMITTED ANGLE OF STRAP FROM VERTICAL IS 45 DEGREES. LOCATE ANCHORS VERTICALLY INTO THE GROUND.



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TIEDOWN SCHEDULE FOR EXPOSURE B

DATE: 04/10/18 DRAWN BY: RD

SCALE: AS NOTED CHECKED BY: KMB

SHEET:

F-2
SHEET 2 OF 6

TIEDOWN SCHEDULE FOR 111 TO 130 MPH WIND SPEED, EXPOSURE "C"											"C"		
BLDG WIDTH											T)		
VVIDIII	8'-0"	10'-0"	12'-0"	14'-0"	16'-0"	18'-0"	20'-0"	22'-0"	24'-0	26'-0"	28'-0"	30'-0"	32'-0"
6'-0"	2	2	2	N/A	N/A	N/A	N/A	N/A	N/A	N/A	N/A	N/A	N/A
7'-11" 1/2"	2	2	2	2	2	2	2	2	2	N.A.	N.A.	N.A.	N.A.
9'-11" 1/2"	2	2	2	2	2	2	2	2	2	2	3	3	N.A.
11'-0"	2	2	2	2	2	2	2	2	2	2	3	3	3

TIEDO	WN S	SCHE	DULE	FOR	131 ⁻	TO 16	60 MPI	H WIN	D SPE	EED, E	EXPOS	SURE	"C"
BLDG WIDTH	NUMBER OF TIEDOWNS PER OUTER SKID BY BUILDING LENGTH (FT)											T)	
WIDIN	8'-0"	10'-0"	12'-0"	14'-0"	16'-0"	18'-0"	20'-0"	22'-0"	24'-0	26'-0"	28'-0"	30'-0"	32'-0"
6'-0"	2	2	2	N/A	N/A	N/A	N/A	N/A	N/A	N/A	N/A	N/A	N/A
7'-11" 1/2"	2	2	2	3	3	3	4	4	4	N.A.	N.A.	N.A.	N.A.
9'-11" 1/2"	2	2	2	2	2	3	3	3	3	3	4	4	N.A.
11'-0"	2	2	2	2	2	3	3	3	3	3	4	4	4

- 1. PROVIDE A MINIMUM OF ONE TIEDOWN STRAP AND ANCHOR AT EACH END OF EACH OUTER SKID. EVENLY SPACE THE REMAINING TIEDOWNS.
- 2. WRAP THE STRAP AROUND THE SKID AND ATTACH TO ANCHOR.
- 3. 3. MAXIMUM PERMITTED ANGLE OF STRAP FROM VERTICAL IS 45 DEGREES. LOCATE ANCHORS VERTICALLY INTO THE GROUND.



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TIEDOWN SCHEDULE FOR EXPOSURE C

DATE: 04/10/18 DRAWN BY: RD

SCALE: AS NOTED CHECKED BY: KMB

F-3
SHEET 3 OF 6

SHEET:

GROUND ANCHOR SCHEDULE										
MODEL#	PART#	DESCRIPTION	SOIL CLASS							
M12H5/8	59080 / 59081	48" X 5%" ROD WITH (1) 6" HELIX	4A							
M12H3/4	59085 / 59094	48" X ¾" ROD WITH (1) 6" HELIX	4A							
M1423/4	59128	42" X $^3\!\!4$ " ROD WITH (2) 4" HELIX	4A							
M1483/4	59086	48" X $\frac{3}{4}$ " ROD WITH (2) 4" HELIX	4A							
M12H64	59250	36" X $^3\!\!4$ " ROD WITH (1) 4" HELIX AND (1) 6" HELIX	4A							
N/A	59065	EYE ANCHOR - 48" X $^{5}\!\!$ " WITH (1) 6" HELIX	4A							
N/A	59045	EYE ANCHOR - 48" X $^3\!\!/_{\!\!4}$ " WITH (1) 6" HELIX	4A							
M607	59099	60" X ¾" WITH (1) 7" HELIX	4B							
N/A	59040	EYE ANCHOR - 60" X $^3\!\!/_{\!\!4}$ " WITH (1) 8" HELIX	4B							

NOTES:

- 1. ALL APPROVED ANCHORS LISTED ABOVE ARE MANUFACTURED BY TIE DOWN ENGINEERING.
- 2. THE CONTRACTOR MAY USE AN APPROVED EQUIVALENT WITH APPROVAL FROM THE EOR.
- 3. ANCHORS SHALL BE INSTALLED PER MANUFACTURER INSTRUCTIONS.

FL License #: 50421
COA# 30468

M. 8
CENS
No 50421
STATE OF

Engineer: Kent Bice

04/12/18

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GROUND ANCHOR SCHEDULE


DATE: 04/10/18 DRAWN BY: RD

SCALE: AS NOTED CHECKED BY: KMB

SHEET:

F-4
SHEET 4 OF 6

ANS WERE DESIGNED IN ACCORDANCE WITH THE 6TH EDITION 2017 FLORIDA BLIII DING CO

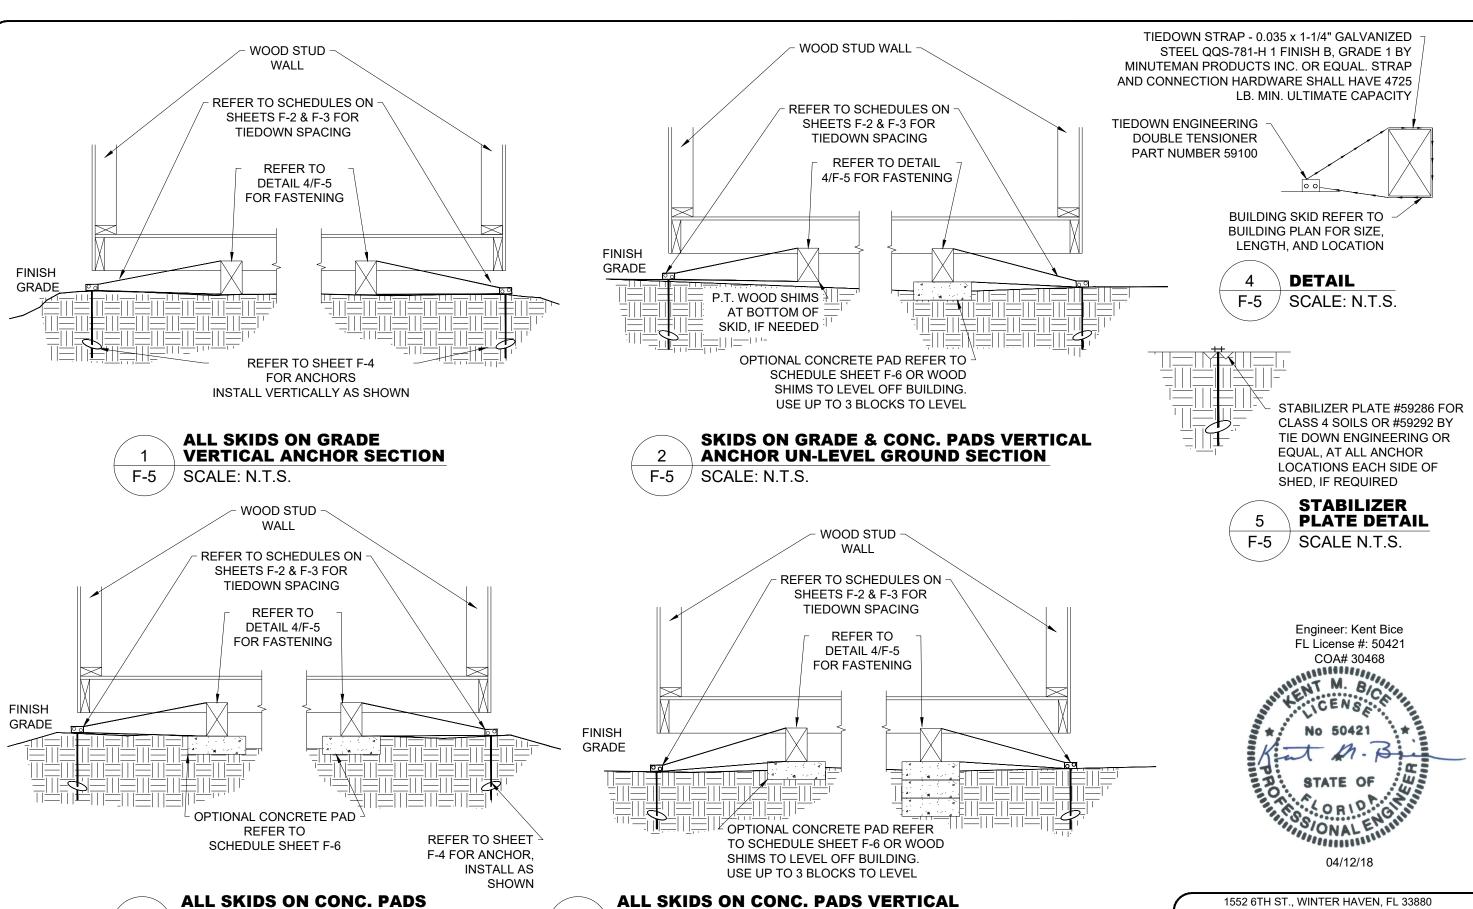

ANCHOR UN-LEVEL GROUND SECTION

SCALE N.T.S.

VERTICAL ANCHOR SECTION

SCALE: N.T.S.

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TIEDOWN SECTIONS

DRAWN BY: RD CHECKED BY: KMB

SHEET 5 OF 6

SHEET:


DATE: 04/10/18 SCALE: AS NOTED

NOTE:


- 1. 4" MIN. THICK, 2500 PSI MIN. CONCRETE PADS ARE OPTIONAL.
- 2. DIMENSIONS SHOWN ARE NOMINAL.
- 3. TIEDOWNS ARE REQUIRED MIN. (4) PER BUILDING, (1) AT EACH CORNER SHEARWALL (SW#).
- 4. REFER TO SCHEDULES ON SHEET F-2 & F-3 FOR TIEDOWN SPACING AND SCHEDULES ON THIS SHEET FOR OPTIONAL PAD LOCATION.
- 5. SPACE OPTIONAL PADS AT EACH END OF EACH SKID AND EQUALLY IN-BETWEEN.
- 6. LOCATE PAD CENTERED UNDER THE SKID.

			EXP	OSUF	RES, A	AND 4	40 PS	F FL	OOR	LOAD)			
BLDG	WIDTH		NUMBER OF PADS REQUIRED BY BUILDING LENGTH UNDER EACH SKID											
BLBO	WIDTH	8'-0"	10'-0"	12'-0"	14'-0"	16'-0"	18'-0"	20'-0"	22'-0"	24'-0"	26'-0"	28'-0"	30'-0"	32'-0'
	6'-0"	3	3	3	N/A									
SINGLE WIDE	7'-11 ½"	3	3	3	4	4	4	5	5	5	N.A.	N.A.	N.A.	N.A.
UNITS	9'-11 ½"	2	3	3	3	3	4	4	4	4	5	5	5	N.A.
	11'-0"	2	3	3	3	3	4	4	4	4	5	5	5	5


16" X 16" X 4" OR (2) 16" X 8" X 4" PAD SCHEDULE FOR ALL WIND SPEEDS,

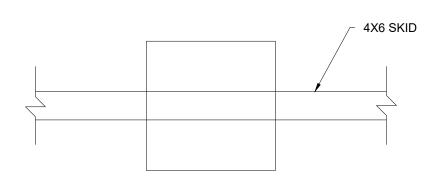




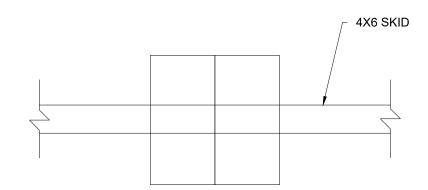

2 **(2) 16"X8"X4" PAD DETAIL** F-6 SCALE: N.T.S.

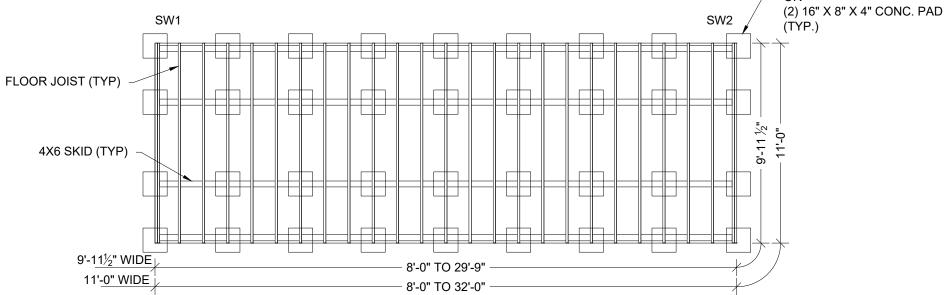

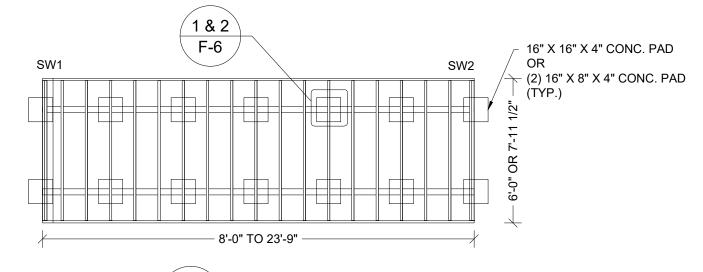

F-6 SCALE: N..T.S.

Engineer: Kent Bice
FL License #: 50421
COA# 30468

N. 50421
STATE OF

04/12/18

16" X 16" X 4" CONC. PAD

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OPTIONAL PAD DETAILS

DATE: 04/10/18 DRAWN BY: RD

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SHEET: **F-6**SHEET 6 OF 6