

FLA Manufactured Building Program 2601 Blair Stone Road Tallahassee, Florida 32399-0772 Phone: 850.487.1824• Fax: 850.414.8436

Halsey Beshears, Secretary

Ron DeSantis, Governor

July 07, 2020

doug oliver

Cook Portable Warehouse 100 Douglas Street Valdosta, GA 31601

RE: Manufacturer Certification, ID MFT-1435; Expiration Date: July 07, 2023

Dear doug oliver

It is my pleasure to inform you that Cook Portable Warehouse, located at 100 DOUGLAS STREET, VALDOSTA, GA 31601, has been approved under the Manufactured Buildings Program, as provided for under Chapter 553, Part I, Florida Statutes, to manufacture Storage Sheds, Manufactured Buildings for installation in Florida.

Construction or modification on a manufactured building cannot begin until the Third Party Agency has approved the plans in accordance with the current Florida Building Code. Your Third Party Agency is a contractor for the Department and has statutory authority and responsibilities that must be met to maintain approved status. You may expect and demand quality plans review and inspections.

Each Code change will make your plans obsolete until they have been reviewed, approved and indicated [on the cover page of the plans] for compliance with the Code by your Third Party Agency for plans review. Please ensure that your plans are in compliance and are properly posted on our website. All site-related installation issues are subject to the local authority having jurisdiction.

The Department's contractor will make unannounced monitoring visits at least once each year. You must grant complete access to your manufacturing facility and records to remain in compliance with the rules and regulations of this program.

Your certification is approved for three years from this date. You will receive a renewal notice by Email generated by the BCIS (<a href="www.floridabuilding.org">www.floridabuilding.org</a>) for online renewal. If you have questions you may contact Robert Lorenzo at 850-717-1835 or our FAX at 850-414-8436.

Please visit our website at <a href="www.floridabuilding.org">www.floridabuilding.org</a> to see valuable information on the Florida Manufactured Buildings Program. A copy of this letter must accompany applications for local building permits.

Sincerely, Part Lugo

Robert Lorenzo

Manufactured Buildings Program

cc: Top Line Engineering, LLC



Tel +1 407 304 5560 Fax +1 407 304 5561 intertek.com/building



July 23, 2018

Mr. Thomas Campbell
Florida Department of Business and Professional Regulation
Manufactured Building Program
1940 North Monroe Street
Suite 90A
Tallahassee, Florida 32399-0772

RE: Plan Approval: Residential Lawn Storage Shed

Manufacturer: Cook Portable Warehouse

Agency Plan Number: 2017-30 R-2

Dear Mr. Thomas,

Professional Service Industries Inc., an Intertek company ("Intertek-PSI"), part of Intertek<sup>1</sup> Building Science Solutions, in pursuant to the requirements of the Florida Department of Business and Professional Regulations, the above referenced documents have been reviewed for compliance with:

2017 Florida Building Code, 6<sup>th</sup> Edition

2014 NEC, NFPA 70

These plans comply with Florida Product Approval Rule 61G20-3.006 (FAC). A signed and sealed set of plans are maintained on file in the Third-Party Agency office of PSI.

All mandatory comments have been satisfied and plans are approved for construction by a modular building manufacturer that is currently approved by the Department of Business and Professional Regulations.

If you have any questions or require my assistance in any way, please do not hesitate to contact me.

Yours sincerely,

Professional Service Industries, Inc.

Richard Olds, ICC #5107840

Plans Examiner

**Business Science Solutions** 

**Peter Craig** 

Department Manager

**Building Science Solutions** 

CC: Doug Oliver – Cook Portable Buildings, Inc. – doliver@cookstuff.com



# COOK PORTABLE WAREHOUSES

100 DOUGLAS ST., VALDOSTA, GA 31601 132 CENTRAL INDUSTRIAL ROW, PURVIS, MS 39475 1398 HWY 95 NORTH, BASTROP, TX 78602

## **STANDARD UTILITY SHED**

STATE OF FLORIDA

	<del>-</del>
	Design Criteria
BUILDING CODE	6TH EDITION, 2017 FLORIDA BUILDING CODE
ELECTRICAL CODE	2014 NEC, NFPA70
BUILDING TYPE	RESIDENTIAL LAWN STORAGE SHED
MANUFACTURER	COOK PORTABLE WAREHOUSES
AGENCY	PSI
AGENCY PLAN NUMBER	UTILITY 2017 FBC
CONSTRUCTION TYPE	V-B
FIRE PROTECTION	В
FIRE SUPPRESSION SYSTEM	NO
OCCUPANCY	U - UTILITY
NUMBER OF OCCUPANTS	0
ALLOWABLE # OF STORIES	1
WIND INFORMATION	160 MPH ULTIMATE; EXPOSURE C, CATEGORY I; ENCLOSED; +/- 0.18 INTERNAL PRESSURE COEFFICIENT; 15' HEIGHT
FLOOR LIVE LOAD	40.0 PSF
FLOOR DEAD LOAD	4.0 PSF
ROOF LIVE LOAD	20.0 PSF
ROOF DEAD LOAD	7.0 PSF
WALL DEAD LOAD	3.0 PSF
UNINHABITED LOFT LIVE LOAD	10.0 PSF
GROUND SNOW LOAD	0.0 PSF
FIRE RATING OF EXTERIOR WALLS	0
"R" RATING OF FLOOR, WALL, AND ROOF	R-0, R-0, R-0
MODULES PER BUILDING	1
SQUARE FOOTAGE	LESS THAN 719 SQ. FT.
EXEMPT FROM ENERGY CONSERVATION CODE?	YES
APPROVED FOR HURRICANE PROTECTION USAGE?	NO
DESIGNED FOR HURRICANE PUBLIC SHELTER?	NO

### SITE INSTALLED ITEMS:

NOTE THAT THIS LIST DOES NOT NECESSARILY LIMIT THE ITEMS OF WORK AND MATERIALS THAT MAY BE REQUIRED FOR A COMPLETE INSTALLATION. ALL SITE RELATED ITEMS ARE SUBJECT TO LOCAL JURISDICTION APPROVAL.

- THE COMPLETE FOUNDATION
   SUPPORTING AND TIE-DOWN SYSTEM.
- RAMPS, STAIRS, AND GENERAL ACCESS TO THE BUILDING IF NECESSARY.
- 3. GUTTERS AND DOWN SPOUTS ON ALL BUILDINGS WITH EAVES OF LESS THAN 6 INCHES HORIZONTAL PROJECTION EXCEPT FOR GABLE END RAKES.

#### **OCCUPANCY NOTE:**

THIS BUILDING IS NOT DESIGNED FOR HUMAN HABITATION AND DOES NOT HAVE RUNNING WATER OR SANITATION SERVICES. THIS BUILDING IS DESIGNED AS A UTILITY SHED TO STORE LAWN EQUIPMENT SUCH AS WHEEL BARROWS, GARDENING SUPPLIES, FLOWER POTS, AND CARDBOARD BOXES WITH VARIOUS SMALL ITEMS.

Sheet Index			
SHEET NUMBER	SHEET TITLE		
S-1	COVER SHEET		
S-2	GENERAL NOTES		
S-3	WIND LOAD TABLES		
S-4	FASTENING SCHEDULE		
S-5	FRAMING PLANS		
S-6	ELEVATION PANEL SIDING		
S-6A	ELEVATION LAP SIDING		
S-7	7'-11 1/2" SHED - FRAMING ELEVATION		
S-8	9'-11 1/2" SHED - FRAMING ELEVATION		
S-9	11'-0" SHED - FRAMING ELEVATION		
S-10	SIDE WALL ELEVATION		
S-11	CROSS SECTIONS		
S-12	CROSS SECTIONS		
S-13	DETAILS		
S-14	DETAILS		
S-15	DETAILS		
S-16	FRAMING & FLOOR PLAN FOR STRAIGHT PORCH		
S-17	ELEVATIONS FOR STRAIGHT PORCH		
S-18	FRAMING & FLOOR PLANS FOR CLIPPED PORCH		
S-19	ELEVATIONS FOR CLIPPED PORCH		
S-20	DETAILS		
S-21	DETAILS		





1552 6TH ST., WINTER HAVEN, FL 33880 (863)865-6502

## **COVER SHEET**

DATE: 07/13/18 DRAWN BY: RD

SCALE: AS NOTED CHECKED BY: KMB

SHEET: S-1
SHEET 1 OF 22

#### **GENERAL NOTES:**

- 1. THIS STRUCTURE WAS DESIGNED IN ACCORDANCE WITH THE 6TH EDITION, 2017 FLORIDA BUILDING CODE, (2017 FBC).
- 2. ALL MATERIALS AND LABOR SHALL BE IN ACCORDANCE WITH THE ABOVE CODE AND ALL OTHER APPLICABLE LOCAL CODES AT THE TIME OF MANUFACTURE.
- 3. WRITTEN DIMENSIONS SHALL TAKE PRECEDENCE OVER SCALED DIMENSIONS.
- 4. THE FOUNDATION PLAN IS A SEPARATE SET OF PLANS FOR APPROVAL BY LOCAL MUNICIPALITIES.
- 5. EXTERIOR DIMENSIONS CAN VARY BETWEEN LIMITS SHOWN AT 2' O.C. BUT MEMBER SPACING SHALL NOT EXCEED LIMITS AS INDICATED
- 6. ALL THE FOLLOWING LUMBER SHALL BE PRESSURE TREATED IN ACCORDANCE WITH AWPA USE CATEGORY UC4B (GROUND CONTACT, HEAVY DUTY)-SKIDS.
- 7. ALL THE FOLLOWING LUMBER SHALL BE PRESSURE TREATED IN ACCORDANCE WITH AWPA USE CATEGORY UC3B (EXTERIOR ABOVE GROUND, UNCOATED OR POOR WATER RUNOFF)-FLOOR JOISTS, PLYWOOD FLOOR DECKING, AND EXTERIOR RATED WOOD STRUCTURAL PANEL SIDING.
- 8. ALL FASTENERS AND CONNECTORS IN CONTACT WITH PRESSURE TREATED WOOD SHALL BE HOT DIPPED GALVANIZED (G185) OR STAINLESS STEEL.
- 9. ALL WINDOWS WITHIN 24" OF DOORS, AND ALL GLASS IN DOORS SHALL BE SAFETY, TEMPERED, OR ACRYLIC PLASTIC SHEET.
- 10. FOR ROOFS WITH ASPHALT SHINGLES AND A SLOPE BETWEEN 2 TO 12 AND 4 TO 12 SHALL HAVE A DOUBLE UNDERLAYMENT APPLICATION AS REQUIRED IN ACCORDANCE WITH SECTION 1507.2.2 OF THE 2017 FBC OR PER SHINGLE MANUFACTURER INSTRUCTIONS.
- 11. UNDERLAYMENT SHALL CONFORM WITH SECTION 1507.2.3 OF THE 2017 FBC OR PER SHINGLE MANUFACTURER INSTRUCTIONS.
- 12. ASPHALT SHINGLES SHALL CONFORM WITH SECTION 1507.2.5 OF THE 2017 FBC ATTACHMENT OF ASPHALT SHINGLES SHALL CONFORM WITH 1507.2.7 OF THE 2017 FBC.
- FASTENERS FOR ASPHALT SHINGLES SHALL CONFORM TO SECTION 1507.2.6 OF THE 2017 FBC.
- 14. TIE-DOWNS SHALL MEET THE REQUIREMENTS OF ALL APPLICABLE CODES.
- 15. THESE PLANS HAVE NOT BEEN DESIGNED FOR HVHZ REQUIREMENTS AS SET FORTH IN THE 2017 FBC OR FOR USE AS A COMMERCIAL BUILDING.
- 16. THE CONTRACTOR SHALL BE RESPONSIBLE FOR VERIFYING ALL EXISTING CONDITIONS.
- 17. THE CONTRACTOR SHALL BE RESPONSIBLE FOR DELIVERY AND PLACEMENT OF LAWN STORAGE UNIT TO ENSURE THE INTEGRITY OF THE BUILDING AND ITS COMPONENT PARTS.
- 18. NO FIELD REVISIONS TO ANY STRUCTURAL COMPONENTS OR DEVIATIONS FROM THESE DRAWINGS SHALL BE MADE.
- 19. THE OWNER AND THE CONTRACTOR SHALL HOLD HARMLESS THE ENGINEER FROM AND AGAINST ALL LIABILITY CLAIMS, DAMAGES, LOSSES AND EXPENSES INCLUDING LEGAL FEES ARISING OUT OF OR RESULTING FROM ERRORS OR OMISSIONS IN THE PERFORMANCE OF THE WORK BY THE CONTRACTOR.
- 20. SECTIONS AND DETAILS ON THE DRAWINGS ARE INTENDED TO BE TYPICAL AND SHALL APPLY AT ALL SIMILAR LOCATIONS, UNLESS OTHER SECTIONS AND DETAILS ARE SPECIFICALLY REFERENCED.
- 21. REFER TO SUPPLIED FASTENING SCHEDULE FOR FASTENING BASED ON CONNECTION AND LOCATION OF MEMBERS AS PER 2017 FBC TABLE 2304.10.1 UNLESS NOTED OTHERWISE.
- 22. BUILDINGS HAVE BEEN DESIGNED FOR LP SMARTSIDE STRAND SUBSTRATE PANEL SIDING, LP SMARTSIDE PRECISION LAP SIDING SHALL BE USED WITH X-STRAPS OR STRUCTURAL SHEATHING AS DETAILED IN THIS PLAN SET
- 23. FASTENERS IN LP SMARTSIDE STRAND SUBSTRATE PANEL SIDING MUST NOT BE INSTALLED IN PANEL SIDING GROOVES IN THE FIELD OF THE PANEL SIDING OR WHEN THE PANEL SIDING GROOVES OCCUR AT CUT EDGES OF THE PANEL SIDING.
- 24. REFER TO THE ICC-ES EVALUATION REPORT ESR-1301 / 3090 FOR ADDITIONAL DATA AND SPECIFICATIONS OF LP SMARTSIDE STRAND SUBSTRATE PANEL / LAP SIDING.
- 25. MAX OPENINGS WIDTHS MUST COMPLY WITH DESIGN RATIOS AS PER ANSI/AF&PA SDPWS-2015. BUILDINGS HAVE BEEN DESIGNED TO HAVE ONLY OPENINGS WITH MAX WIDTHS EQUAL TO THOSE IN THE ENDWALL SHEAR WALL CHART.
- 26. PER SECTION 1609.1.2 OF THE 2017 FBC, STORAGE SHEDS THAT ARE NOT DESIGNED FOR HUMAN HABITATION AND THAT HAVE A FLOOR AREA OF 720 SQUARE FEET OR LESS ARE NOT REQUIRED TO COMPLY WITH THE MANDATORY WIND-BORNE-DEBRIS-IMPACT STANDARDS OF THE 2017 FBC.
- 27. BUILDINGS THAT ARE 400 SQUARE FEET OR LESS AND THAT ARE INTENDED FOR USE IN CONJUNCTION WITH ONE-AND-TWO-FAMILY RESIDENCES ARE NOT SUBJECT TO THE DOOR HEIGHT AND WIDTH REQUIREMENTS OF THE 2017 FBC PER 1010.1.1 (SEE EXCEPTION 8).
- 28. BUILDINGS HAVE BEEN DESIGNED TO HAVE ANCHORS DIRECTLY ATTACHED TO ALL FOUR CORNERS OF THE BUILDING TO RESIST TENSION FORCES FROM LATERAL WIND LOADS.
  THIS DESIGN CONSIDERATION MUST BE MADE BY INSTALLER WHEN ATTACHING ANCHORING SYSTEM TO BUILDING.
- 29. UNLESS NOTED OTHERWISE, ATTACH ALL MANUFACTURED PRODUCTS IN ACCORDANCE WITH MANUFACTURERS SPECIFICATIONS.
- 30. 2X4 SP #2 PRESSURE TREATED LUMBER SHALL BE SUBSTITUTED FOR 2X4 SPF #2 LUMBER IN WALLS FOR USE IN FLOOD PLAINS.
- 31. PER APA PRODUCT REPORT PR-N124, LP SMARTSIDE STRAND SUBSTRATE SERIES TREATED-ENGINEERED-WOOD PANEL AND LAP SIDING IS PERMITTED ON WALLS FOR USE IN FLOOD PLAINS.
- 32. 19/32" LP PROSTRUCT FLOORING WITH SMARTFINISH IS PERMITTED IN LIEU OF 5/8" APA RATED STRUCTURAL SHEATHING ON FLOOR. INSTALL PER MANUFACTURER INSTRUCTIONS.



Engineer: Kent Bice
FL License #: 50421
COA# 30468

No 50421
STATE OF
ORA

07/13/18

1552 6TH ST., WINTER HAVEN, FL 33880 (863)865-6502

GENERAL NOTES

DATE: 07/13/18 DRAWN BY: RD

SCALE: AS NOTED CHECKED BY: KMB


S-2

SHEET

SHEET 2 OF 22

ANS WERE DESIGNED IN ACCORDANCE WITH THE 6TH EDITION 2017 ELORIDA BLIII DING C

PSI Approval 2018-07-23

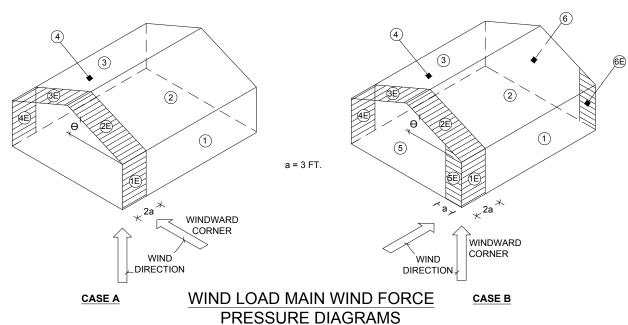



## **DESIGN WIND LOADS - WINDOWS, DOORS, COMPONENTS AND CLADDING**


	ROOF				
ZONE	AREA (FT²)	DESIGN PRESSURE (PSF)			
	(1 1 )	POSITIVE	NEGATIVE		
1	10	50.9	-55.8		
1	20	49.6	-52.9		
1	50	47.7	-49.1		
1	100	46.2	-46.2		
2	10	50.9	-65.2		
2	20	49.6	-62.3		
2	50	47.7	-58.6		
2	100	46.2	-55.8		
3	10	50.9	-65.2		
3	20	49.6	-62.3		
3	50	47.7	-58.6		
3	100	46.2	-55.8		

WALLS				
ZONE	AREA (FT²)	DESIGN PRESSURE (PSF)		
	(1 1 )	POSITIVE	NEGATIVE	
4	10	55.8	-60.5	
4	20	53.2	-58.0	
4	50	49.9	-54.6	
4	100	47.4	-52.2	
5	10	55.8	-74.7	
5	20	53.2	-69.6	
5	50	49.9	-62.9	
5	100	47.4	-58.0	

#### **BUILDING DATA ASCE 7-10 WIND** WIND VELOCITY V<sub>ULT</sub> 160 MPH INTERNAL PRESSURE COEFFICIENT ± 0.18 WIND VELOCITY V<sub>ASD</sub> 124 (ENCLOSED BUILDING ASCE 7-10) **BUILDING CATEGORY** HEIGHT & EXPOSURE ADJUSTMENT COEFFICIENT 1.21 ROOF DEAD LOAD RESISTING UPLIFT (PSF) 7.0 ROOF ANGLE, ° (DEGREES) **60 DEGREES** 38 DEGREES ON AVERAGE MEAN ROOF HEIGHT 15 WIND EXPOSURE CATEGORY

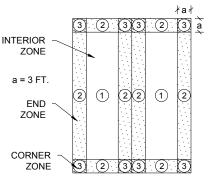

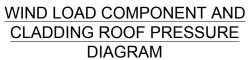

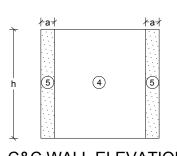

# C&C WALL ELEVATION DIAGRAM

a = 3 FT. MAX. h = 9.5 FT.

#### NOTES:

- 1. FOR EFFECTIVE AREAS BETWEEN THOSE GIVEN ABOVE THE LOAD MAY BE INTERPOLATED, OTHERWISE USE THE LOAD ASSOCIATED WITH THE LOWER EFFECTIVE AREA.
- 2. PLUS AND MINUS SIGNS SIGNIFY PRESSURES ACTING TOWARD AND AWAY FROM THE SURFACES, RESPECTIVELY.
- 3. PRESSURES SHOWN ARE APPLIED NORMAL TO THE SURFACE.
- 4. REFER TO PRESSURE ZONE DIAGRAMS PROVIDED FOR CORRESPONDING ZONES.
- 5. ROOF COVERINGS, FINISHES, ETC SHALL BE DESIGNED FOR THE FULL NEGATIVE DESIGN PRESSURE.

Intertek DE LEGION CONTROLL CO

### **DESIGN WIND LOADS - MWFRS**

		WA	ALL			RO	OF	
	SURFACE 1	SURFACE 1E	SURFACE 4	SURFACE 4E	SURFACE 2	SURFACE 2E	SURFACE 3	SURFACE 3E
LOAD CASE A	35.0	41.2	-26.0	-31.3	24.0	27.9	-27.9	-32.8

	SIDE WALL			ROOF			GABLE WALL					
	WIND	WARD	LEEV	VARD	WIND	WARD	LEEV	VARD	WIND	WARD	LEEV	VARD
	SURFACE 1	SURFACE 1E	SURFACE 4	SURFACE 4E	SURFACE 2	SURFACE 2E	SURFACE 3	SURFACE 3E	SURFACE 5	SURFACE 5E	SURFACE 6	SURFACE 6E
LOAD CASE B	-29.8	-31.3	-29.8	-31.3	-41.2	-59.2	-26.0	-33.6	27.5	37.4	-22.3	-28.9

Engineer: Kent Bice
FL License #: 50421
COA# 30468

No 50421
STATE OF

07/13/18

1552 6TH ST., WINTER HAVEN, FL 33880 (863)865-6502

# WIND LOAD TABLES

DATE: 07/13/18 DRAWN BY: RD

SCALE: AS NOTED CHECKED BY: KMB

SHEET: **S-3**SHEET 3 OF 22

	ASTENING SCHEDULE	
CONNECTION	FASTENING <sup>a, k</sup>	LOCATION
1. JOIST TO SILL OR GIRDER	3 - 8d COMMON (2½" X 0.131") 3 - 3" X 0.131" NAILS 3 - 3", 14 GAGE STAPLES	TOENAIL
2. BRIDGING TO JOIST	2 - 8d COMMON (2½" X 0.131") 2 - 3" X 0.131" NAILS 2 - 3", 14 GAGE STAPLES	TOENAIL EACH END
3. SOLE PLATE TO JOIST OR BLOCKING	16d (3½" X 0.135") AT 12" O.C. 3" X 0.131" NAILS AT 12" O.C. 3", 14 GAGE STAPLES AT 12" O.C.	FACE NAIL
4. SOLE PLATE TO JOIST OR BLOCKING AT BRACED WALL PANEL	3 - 16d (3½" X 0.135") AT 16" O.C. 4 - 3" X 0.131" NAILS AT 16" O.C. 4 - 3", 14 GAGE STAPLES AT 16" O.C.	FACE NAIL
5. TOP PLATE TO STUD	2 - 16d (3½" X 0.162") 3 - 3" X 0.131" NAILS 3 - 3", 14 GAGE STAPLES	END NAIL
6. STUD TO SOLE PLATE	4 - 8d COMMON (2½" X 0.131") 4 - 3" X 0.131" NAILS 4 - 3", 14 GAGE STAPLES	TOENAIL
	2 - 16d COMMON (3½" X 0.162") 3 - 3" X 0.131" NAILS 3 - 3", 14 GAGE STAPLES	END NAIL
7. DOUBLE STUDS	16d (3½" X 0.162") AT 24" O.C. 3" X 0.131" NAILS AT 16" O.C. 3", 14 GAGE STAPLES AT 16" O.C.	FACE NAIL
8. TOP PLATE TO TOP PLATE	16d (3½" X 0.162") AT 16" O.C. 3" X 0.131" NAILS AT 12" O.C. 3", 14 GAGE STAPLES AT 12" O.C.	FACE NAIL
	8 - 16d COMMON (3½" X 0.162") 12 - 3" X 0.131" NAILS 12 - 3", 14 GAGE STAPLES	FACE NAIL AT LAP SPLICE
9. BLOCKING BETWEEN JOISTS OR RAFTERS TO TOP PLATE	3 - 8d COMMON (2½" X 0.131") 3 - 3 X 0.131" NAILS 3 - 3", 14 GAGE STAPLES	TOENAIL
10. RIM JOIST TO TOP PLATE	8d (2½" X 0.131") AT 6" O.C. 3" X 0.131" NAILS AT 6" O.C. 3", 14 GAGE STAPLES AT 6" O.C.	TOENAIL
11. TOP PLATES, LAPS AND INTERSECTIONS	2 - 16d COMMON (3½" X 0.162") 3 - 3" X 0.131" NAILS 3 - 3", 14 GAGE STAPLES	FACE NAIL
12. CONTINUOUS HEADER (2) PIECES	16d COMMON (3½" X 0.162")	16" O.C. EACH EDGE, FACE NAIL
13. CEILING JOISTS TO PLATE	3 - 8d COMMON (2½" X 0.131") 3 - 3" X 0.131" NAILS 3 - 3", 14 GAGE STAPLES	TOENAIL
14. CONTINUOUS HEADER TO STUD	4 - 8d COMMON (2½" X 0.131")	TOENAIL
15. RAFTER TO PLATE	3 - 16d (3½" X 0.162") 4 - 3" X 0.131" NAILS 4 - 3", 14 GAGE STAPLES	TOENAIL
16. 1" DIAGONAL BRACE TO EACH STUD AND PLATE	2 - 8d COMMON (2½" X 0.131") 2 - 3" X 0.131" NAILS 3 - 3", 14 GAGE STAPLES	FACE NAIL
17. BUILT-UP CORNER STUDS	16d (3½" X 0.162") 3" X 0.131" NAILS 3" 14 GAGE STAPLES	12" O.C. FACE NAIL

$\neg$				
		FASTENIN	G SCHEDULE	
	CONNECTION		FASTENING <sup>a, k</sup>	LOCATION
	18. BUILT-UP GIRDER AND BEAMS	3" X 0.131" NA	(4" X 0.192") at 32" O.C. IL AT 24" O.C. TAPLE AT 24" O.C. AND	FACE NAIL AT TOP AND BOTTOM STAGGERED ON OPPOSITE SIDES
		3 - 3" X 0.131" 3 - 3" 14 GAGE	STAPLE	FACE NAIL AT ENDS AND AT EACH SPLICE
	19. COLLAR TIE TO RAFTER	3 - 10d COMM 4 - 3" X 0.131" 4 - 3" 14 GAGE		FACE NAIL
	20. ROOF RAFTER TO 2-BY RIDGE BEAM	3 - 10d COMM 4 - 3" X 0.131" 4 - 3" 14 GAGE		TOENAIL
	21. JOIST TO BAND JOIST	3 - 16d COMM 4 - 3" X 0.131" 4 - 3" 14 GAGE	_	END NAIL
	22. WOOD STRUCTURAL PANELS AND PARTICLEBOARD <sup>b</sup> , SUBFLOOR, ROOF AND WALL SHEATHING (TO FRAMING)  SINGLE FLOOR, COMBINATION SUBFLOOR-UNDERLAYMENT TO FRAMING	1/ <sub>2</sub> " AND LESS 19/ <sub>32</sub> " TO 3/ <sub>4</sub> " 7/ <sub>8</sub> " TO 1" 11/ <sub>8</sub> " TO 11/ <sub>4</sub> "	6d <sup>c</sup> , J 2 <sup>3</sup> / <sub>8</sub> " X 0.113" NAIL <sup>1</sup> 1 <sup>3</sup> / <sub>4</sub> " X 16 GAGE <sup>m</sup> STAPLE 8d <sup>d</sup> OR 6d <sup>e</sup> 2 <sup>3</sup> / <sub>8</sub> " X 0.113" NAIL <sup>n</sup> 2" 16 GAGE <sup>n</sup> STAPLE 8d <sup>c</sup> 10d <sup>d</sup> OR 8d <sup>e</sup>	6" O.C. AT EDGES AND 12" O.C. AT INTERMEDIATE, 4" O.C. AT COMPONENT AND CLADDING EDGE STRIP # ZONE 3 [REFER TO FIGURE ON SHEET S-3]
	23. PANEL SIDING TO FRAMING	½" OR LESS 5/8"	6d <sup>f</sup> 8d <sup>f</sup>	6" / 12" O.C. AT EDGES / INTERMEDIATE
	24. FIBERBOARD SHEATHING  intertek  OSI  CODE REVIEW  Professional Service Industries, Inc  An Intertek Company 1748 3374 Street  Orlando, Florida 32839  Plans Reviewer: Richard Olds ICC #5107840  FI. #SMP-45, SMI-76 LSUCCC #U02416  Department Manager: Peter Craig	1/2"	NO. II GAGE ROOFING NAIL <sup>h</sup> 6d COMMON NAIL (2" x 0.113") NO. 16 GAGE STAPLE <sup>i</sup> NO. II GAGE ROOFING NAIL <sup>h</sup> 8D COMMON NAIL (2 ½" x 0.131") NO 16 GAGE STAPLE <sup>i</sup>	3" / 6" O.C. AT EDGES / INTERMEDIATE FOR STRUCTURAL APPLICATIONS 6" / 12" O.C. AT EDGES / INTERMEDIATE FOR NON-STRUCTURAL APPLICATIONS

#### NOTES:

- a. COMMON OR BOX NAILS ARE PERMITTED TO BE USED EXCEPT WHERE OTHERWISE STATED.
- b. NAILS SPACED AT 6' O.C. AT EDGES, 12" AT INTERMEDIATE SUPPORTS EXCEPT 6" AT SUPPORTS WHERE SPANS ARE 48" OR MORE. NAILS FOR WALL SHEATHING ARE PERMITTED TO BE COMMON, BOX OR CASING.
- c. COMMON OR DEFORMED SHANK (6d 2" x 0.113"; 8d 2 1/2" x 0.131"; 10d 3" x 0.148").
- d. COMMON (6d 2" x 0.113"; 8d 2 1/2" x 0.131"; 10d x 0.148").
- e. DEFORMED SHANK (6d 2" x 0.113"; 8d 2 1/2" x 0.131"; 10d 3" x 0.148").
- f. CORROSION-RESISTANT SIDING (6d 1 7/8" x 0.106"; 8d 2 3/8' x 0.128") OR CASING (6d 2" x 0.099"; 8d 2 1/2" x 0.113") NAIL.
- g. FASTENERS SPACED 3" O.C. AT EXTERIOR EDGES AND 6" O.C. AT INTERMEDIATE SUPPORTS, WHEN USED AS STRUCTURAL SHEATHING. SPACING SHALL BE 6" O.C. ON THE EDGES AND 12" O.C. AT INTERMEDIATE SUPPORTS FOR NONSTRUCTURAL APPLICATIONS.
- h. CORROSION-RESISTANT ROOFING NAILS WITH 7/16" DIAMETER HEAD AND 1 1/2" LENGTH FOR 1/2" SHEATHING AND 1 3/4" LENGTH FOR 25/32" SHEATHING.
- CORROSION-RESISTANT STAPLES WITH NOMINAL 7/16" CROWN OR 1" CROWN AND 1 1/4" LENGTH FOR 1/2" SHEATHING AND 1 1/2" LENGTH FOR 25/32" SHEATHING. PANEL SUPPORTS AT 16" (20" IF STRENGTH AXIS IS THE LONG DIRECTION OF THE PANEL, UNLESS OTHERWISE MARKED).
- FOR ROOF SHEATHING APPLICATIONS, 8d NAILS (2 1/2" x 0.113") ARE THE MINIMUM REQUIRED FOR WOOD STRUCTURAL PANELS.
- k. STAPLES SHALL HAVE A MINIMUM CROWN WIDTH OF 7/16'.
- I. FOR ROOF SHEATHING APPLICATIONS, FASTENERS SPACED 4" O.C. AT EDGES, 8" O.C. AT INTERMEDIATE SUPPORTS.
- m. FASTENERS SPACED 4" O.C. AT EDGES, 8" O.C. AT INTERMEDIATE SUPPORTS FOR SUBFLOOR AND WALL SHEATHING AND 3" O.C. AT EDGES, 6" AT INTERMEDIATE SUPPORTS FOR ROOF
- n. FASTENERS SPACED 4" O.C. AT EDGES, 8" AT INTERMEDIATE SUPPORTS.

Engineer: Kent Bice FL License #: 50421

COA# 30468 M. BION OR LENGTH


07/13/18

1552 6TH ST., WINTER HAVEN, FL 33880 (863)865-6502

# **FASTENING SCHEDULE**

DATE: 07/13/18 DRAWN BY: RD SCALE: AS NOTED CHECKED BY: KMB


SHEET: SHEET 4 OF 22

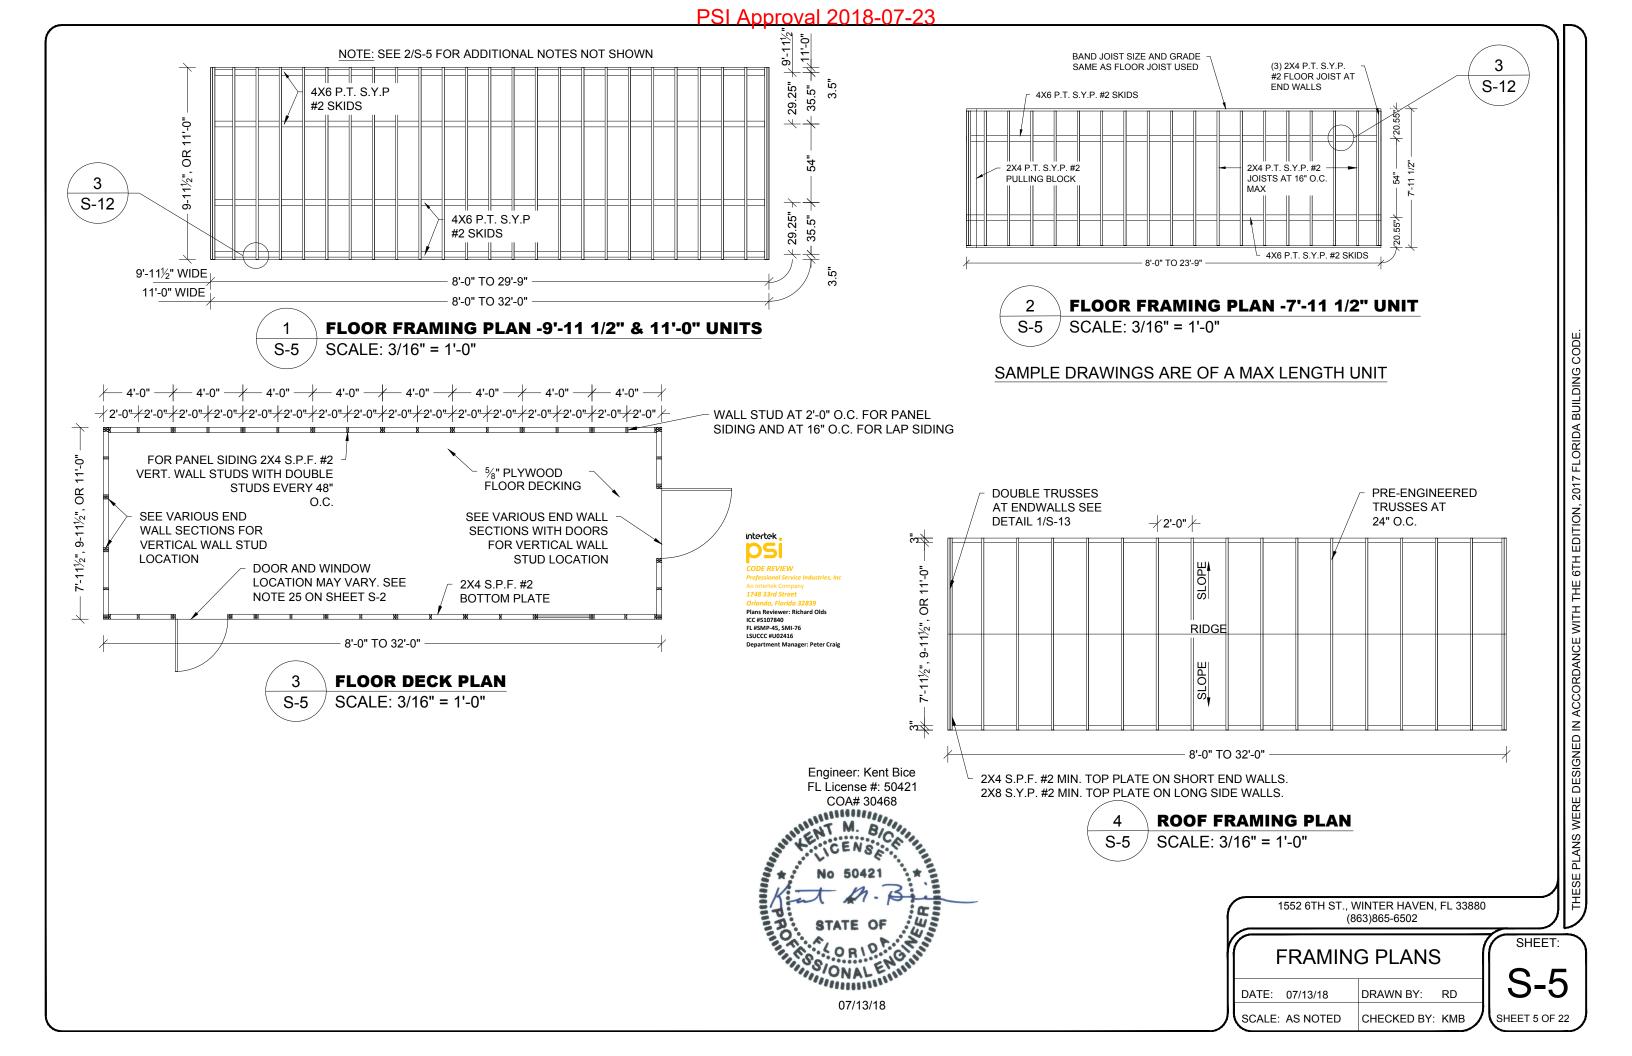

intertek


FL #SMP-45. SMI-76

LSUCCC #U02416

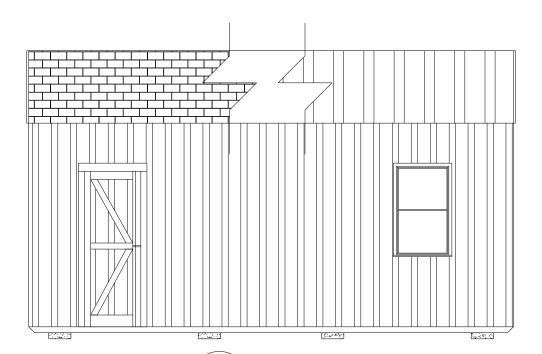


### SIDE WALL ELEVATION WITH PANEL SIDING

SCALE: 1/4" = 1'-0"

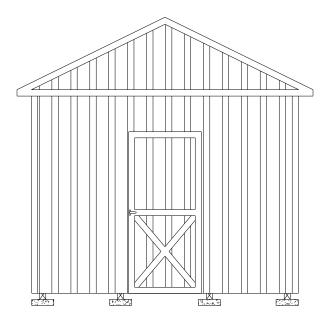



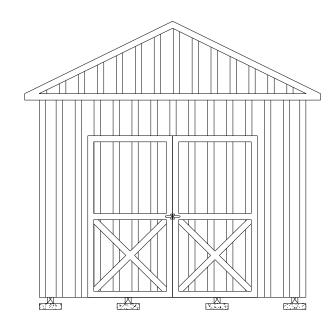

SAMPLE: 11'-0" WIDE UNIT WITH 7'-0" DOOR

**ENDWALL ELEVATION WITH PANEL SIDING** 


SCALE: 1/4" = 1'-0"

SHEARWALL WITH 19/32" T1-11<sup>1</sup> OR LP SMARTSIDE STRAND SUBSTRATE PANEL SIDING<sup>2,3</sup>

FLOOR	OPENI	NG WIDTH	MAX BUILDING LENGTH				
WIDTH (FT)	LONG SIDE WALL	SHORT END WALL	19/32" T1-11 <sup>1</sup>	19/32" LP PANEL <sup>2</sup>	19/32" LP PANEL <sup>3</sup>		
7'-11½"	2'-0", 3'-0", 4'-0", 6'-0"	2'-0", 3'-0", 4'-0"	23'-9"	23'-9"	23'-9"		
9'-11½"	2'-0", 3'-0", 4'-0", 6'-0", 7'-0"	2'-0", 3'-0", 4'-0", 6'-0"	29'-9"	29'-9"	29'-9"		
_	6-0,7-0	7'-0"		26'-0"			
11'-0"	2'-0", 3'-0", 4'-0",	2'-0", 3'-0", 4'-0", 6'-0", 7'-0"	32'-0"	32'-0"	32'-0"		
	6'-0", 7'-0", 8'-0"	8'-0"		26'-0"			

#### NOTES:

- 19/32" T1-11 APA RATED SIDING 303-24 O.C. WITH 8D COMMON OR DEFORMED (0.131"X2-1/2") NAILS AT 6" O.C. IN FIELD AND 3" O.C. IN EDGES.
- 2. 19/32" LP SMARTSIDE STRAND SUBSTRATE PANEL SIDING WITH STAGGERED 8D COMMON OR DEFORMED (0.131"X2-1/2") NAILS AT 6" O.C. IN FIELD AND 3" O.C. IN EDGES.
- 3. 19/32" LP SMARTSIDE STRAND SUBSTRATE PANEL SIDING WITH STAGGERED 8D COMMON OR DEFORMED (0.131"X2-1/2") NAILS AT 6" O.C. IN FIELD AND 2" O.C. IN EDGES.
- 4. WINDOWS AND DOORS MAY BE LOCATED IN EITHER THE SIDE WALL OR ENDWALL. DOORS ARE PERMITTED TO BE IN BOTH ENDWALLS OR ENDWALL AND SIDEWALL IF REQUESTED BY CUSTOMER. LIMITATIONS ON THE TOTAL DIMENSIONS SHALL BE BASED ON THE SHEAR WALL HEIGHT TO WIDTH RATIO OF 3.5:1 AND SHALL NOT EXCEED (2/3) OF THE TOTAL LENGTH OF BUILDING.
- DOOR AND WINDOW SHALL BE LOCATED SUCH THAT THEY ARE AT LEAST 3'3" APART.
- EDGE NAILING SHALL BE PROVIDED AT TOP PLATE IN ALL END WALLS.
- 7. PROVIDE BLOCKING AT ALL UNSUPPORTED EDGES OF WALL SHEATHING.

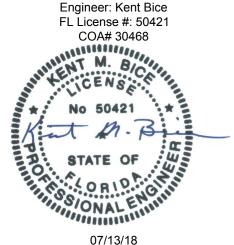

1552 6TH ST., WINTER HAVEN, FL 33880 (863)865-6502

ELEVATIONS AND SHEARWALL					
DATE: 07/13/18	DRAWN BY: RD				
SCALE: AS NOTED	CHECKED BY: KMB				

SHEET:

SHEET 6 OF 22

# ELEVATIONS AND SHEARWALL

DATE: 07/13/18 DRAWN BY: RD

SCALE: AS NOTED CHECKED BY: KMB


S-6A SHEET 7 OF 22

## ENDWALL ELEVATION WITH LAP SIDING

S-6A | SCALE: 1/4" = 1'-0"

(3 S-6A) WALL STUD TIEDOWN FOR X-BRACE OPTION

SCALE: NTS

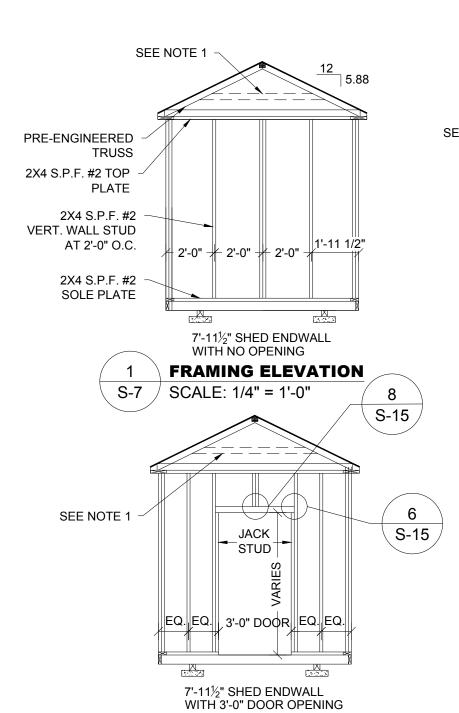

**FRAMING ELEVATION** 

SCALE: 1/4" = 1'-0"

3

S-7

ICC #5107840 FL #SMP-45, SMI-76 LSUCCC #U02416

Department Manager: Peter Craig

SEE NOTE 1

SEE HEADER DETAIL 4/S-15

SEE HEADER DETAIL 4/S-15

7
S-15

JACK
STUD

EQ. 4'-0" DOOR EQ.

7'-11½" SHED ENDWALL WITH 4'-0" DOOR OPENING

2 FRAMING ELEVATION

SCALE: 1/4" = 1'-0"

Engineer: Kent Bice
FL License #: 50421
COA# 30468

M. B

STATE OF

OR

07/13/18

1552 6TH ST., WINTER HAVEN, FL 33880 (863)865-6502


CHECKED BY: KMB

7'-11 1/2" SHED FRAMING ELEVATIONS

DATE: 07/13/18 DRAWN BY: RD


SCALE: AS NOTED

SHEET: **S-7**SHEET 8 OF 22

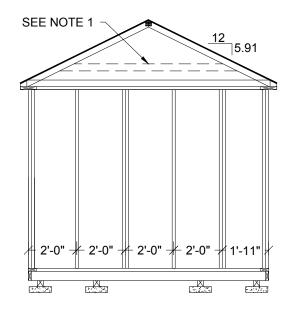


9'-111/2" SHED ENDWALL WITH NO OPENING

FRAMING ELEVATION S-8 SCALE: 1/4" = 1'-0"

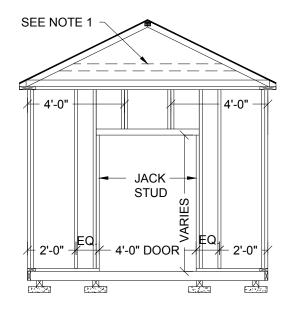


9'-111/2" SHED ENDWALL WITH 4'-0" DOOR OPENING

FRAMING ELEVATION S-8 SCALE: 1/4" = 1'-0"

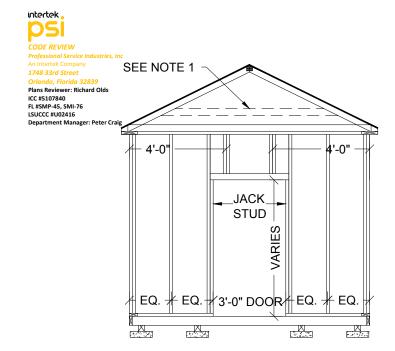


9'-11½" SHED ENDWALL WITH 3'-0" DOOR OPENING

**FRAMING ELEVATION** S-8 SCALE: 1/4" = 1'-0"

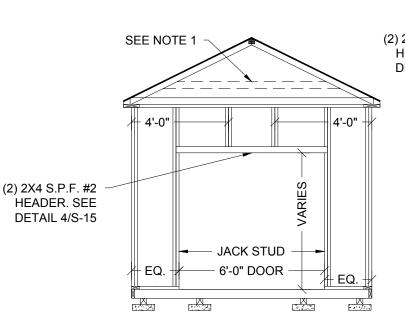

9'-111/2" SHED ENDWALL WITH 6'-0" DOOR OPENING

FRAMING ELEVATION S-8 SCALE: 1/4" = 1'-0"

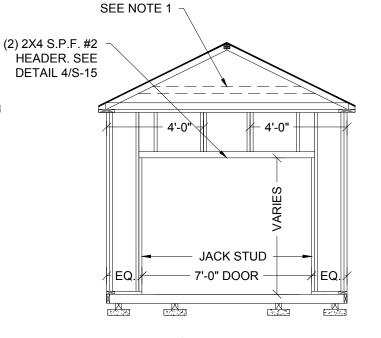

9'-111/2" SHED ENDWALL WITH 7'-0" DOOR OPENING

FRAMING ELEVATION S-8 SCALE: 1/4" = 1'-0"

Engineer: Kent Bice FL License #: 50421 COA# 30468 W Dive NT M. BIC ONAL ENTIN 07/13/18

1552 6TH ST., WINTER HAVEN, FL 33880 (863)865-6502


CHECKED BY: KMB


### 9'-11 1/2" SHED FRAMING ELEVATIONS DRAWN BY: RD DATE: 07/13/18


SCALE: AS NOTED

SHEET:


SHEET 9 OF 22

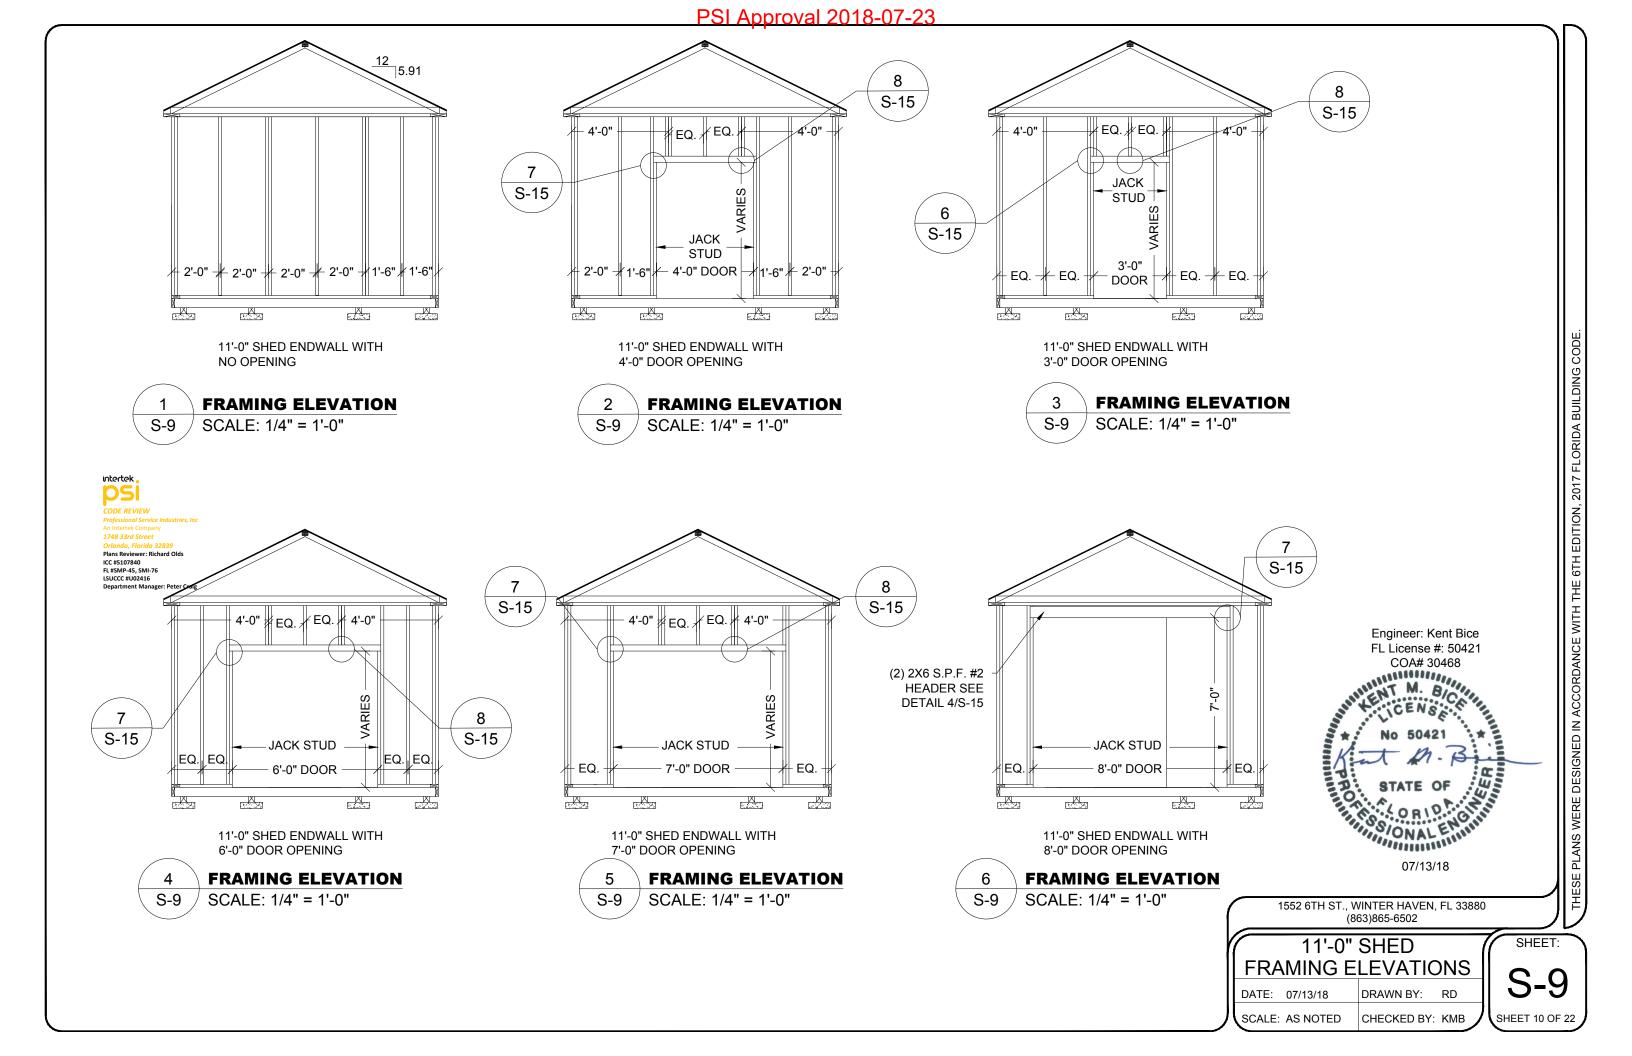


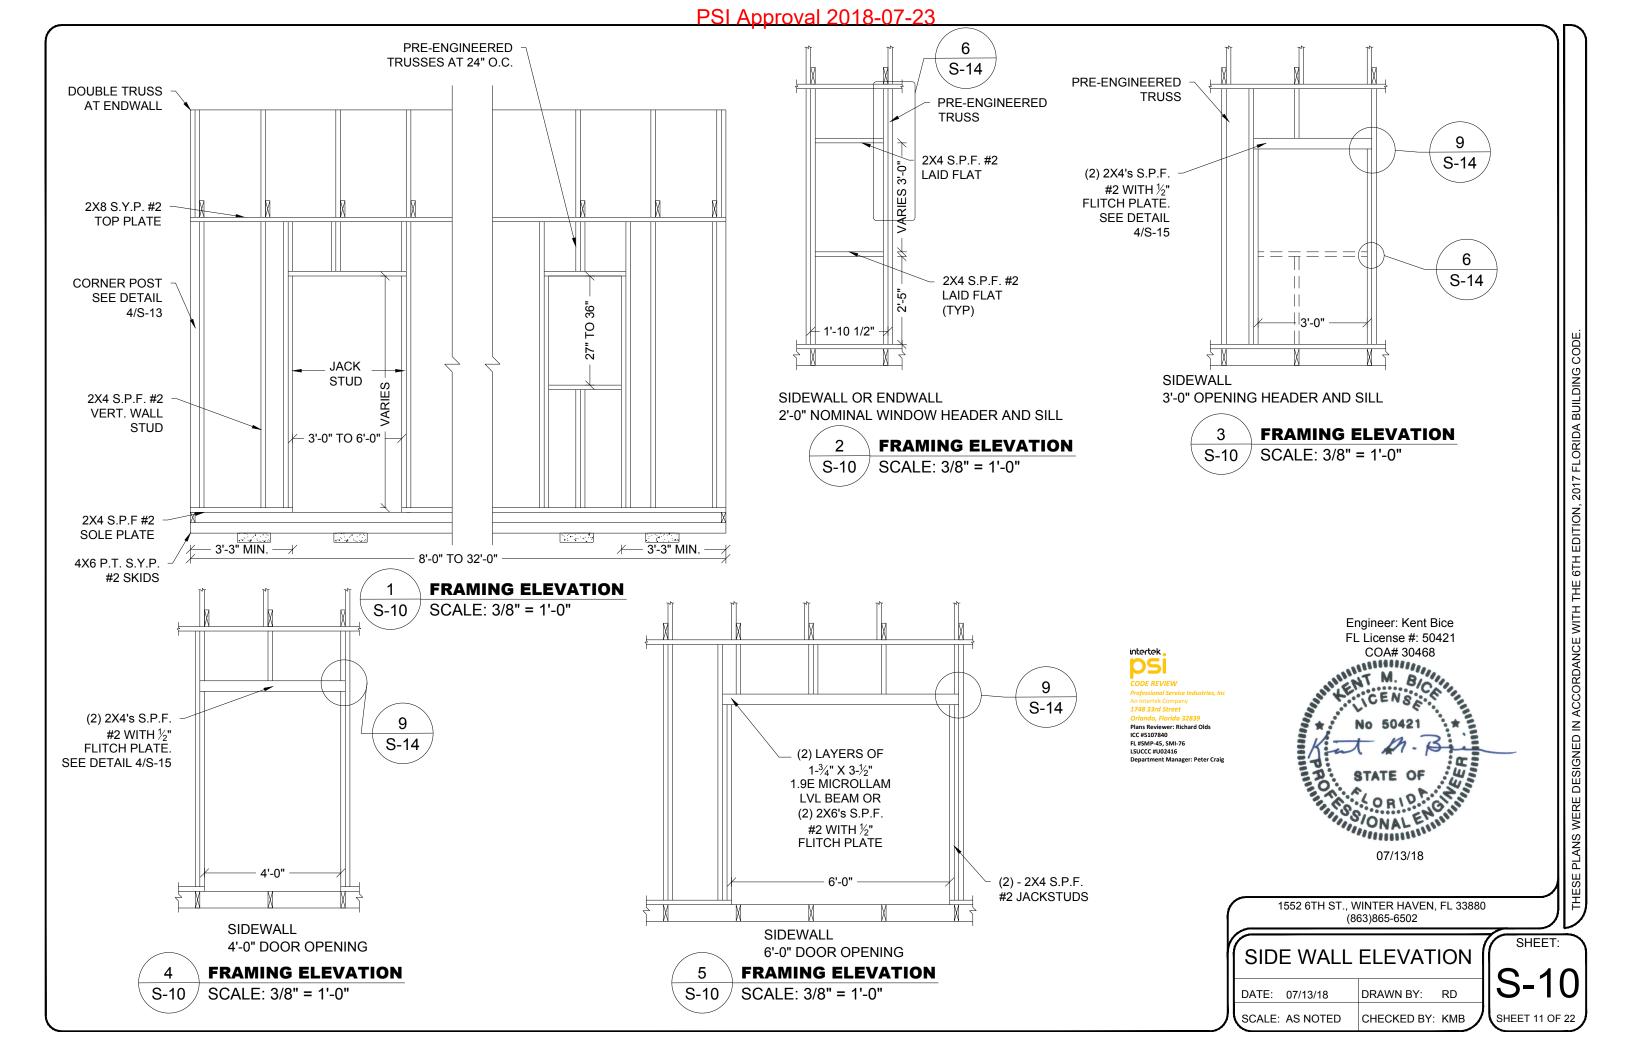


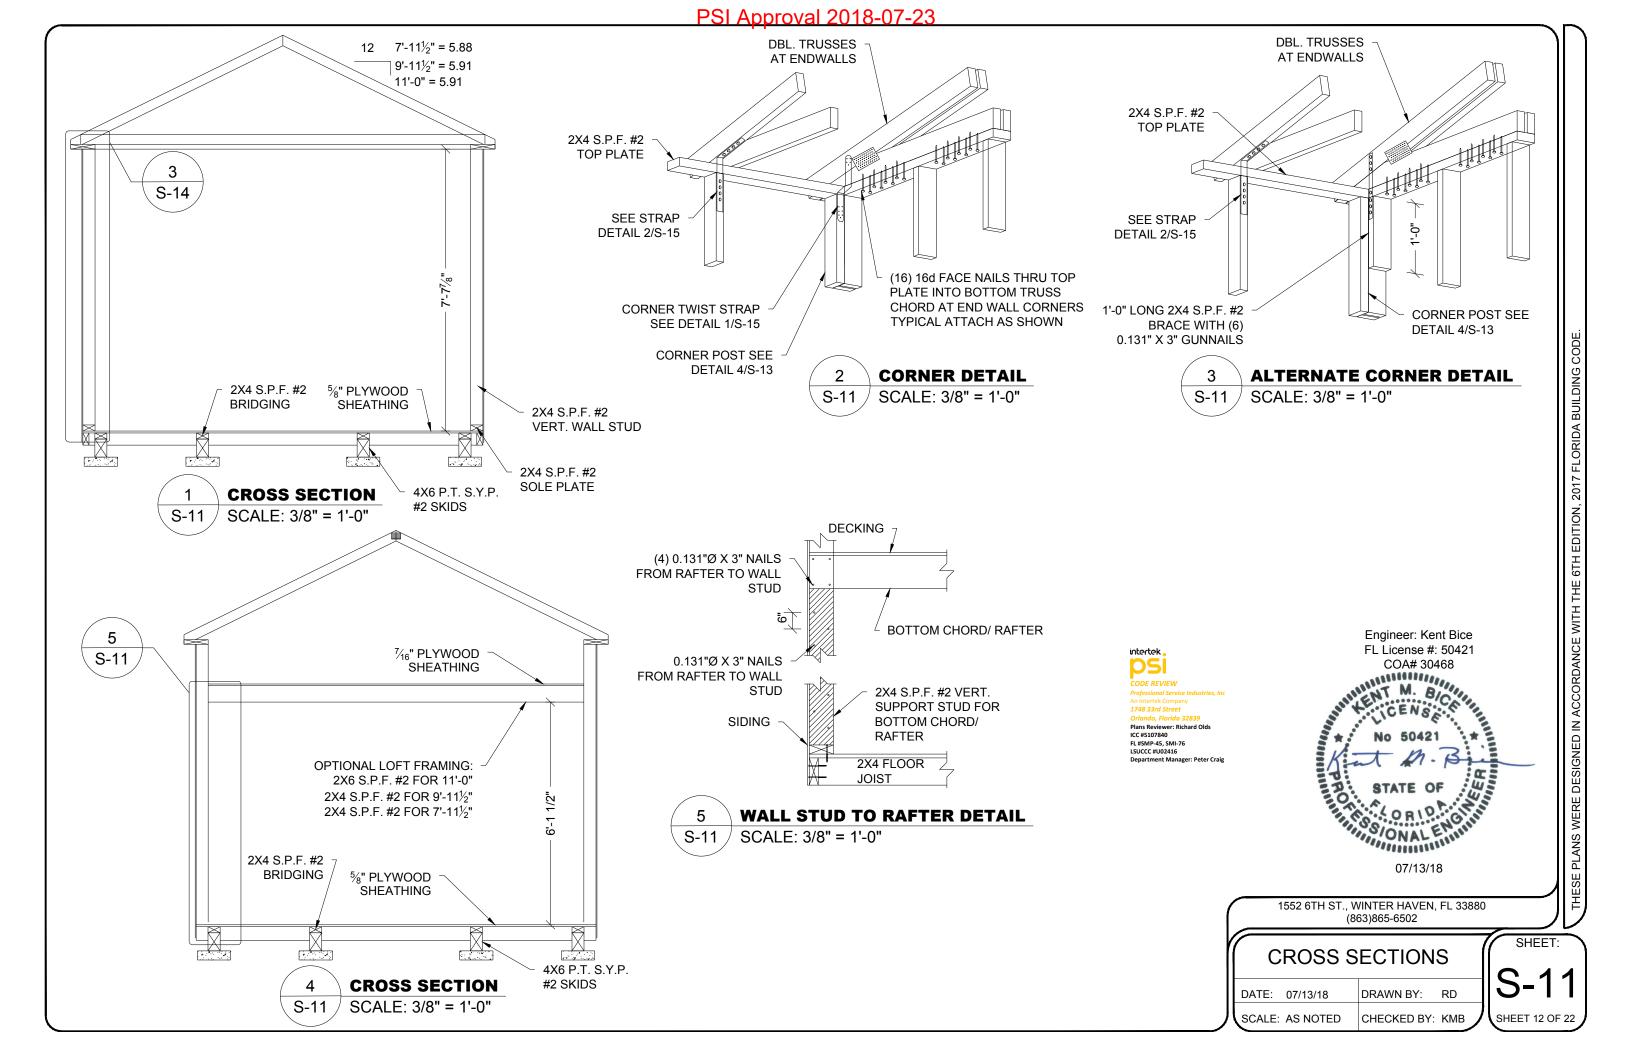

PSI Approval 2018-07-23 9'-11½" WIDE OPTIONAL METAL ROOF 7'-11½" WIDE OPTIONAL METAL ROOF **CROSS SECTION CROSS SECTION** S-12 SCALE: 3/8" = 1'-0" S-12 SCALE: 3/8" = 1'-0" 29 GA. PANEL-LOC PLUS ROOF PANEL RESIDENTIAL BY CENTRAL STATES RIDGE CAP BY MANUFACTURING OR **CENTRAL STATES** Engineer: Kent Bice **EQUAL** MANUFACTURING FL License #: 50421 PART # RRCP OR EQUAL COA# 30468 intertek . RESIDENTIAL 1748 33rd Street **EAVE TRIM BY** Plans Reviewer: Richard Olds ICC #5107840 FL #SMP-45, SMI-76 LSUCCC #U02416 CENTRAL STATES MANUFACTURING PART # RET ORI CONALEMINA OR EQUAL P.T. 1X6 **FASCIA BOARD** 07/13/18 1552 6TH ST., WINTER HAVEN, FL 33880 (863)865-6502 11'-0" WIDE OPTIONAL METAL ROOF SHEET: **CROSS SECTION CROSS SECTIONS** SCALE: 3/8" = 1'-0" DATE: 07/13/18 DRAWN BY: RD SCALE: AS NOTED CHECKED BY: KMB SHEET 13 OF 22

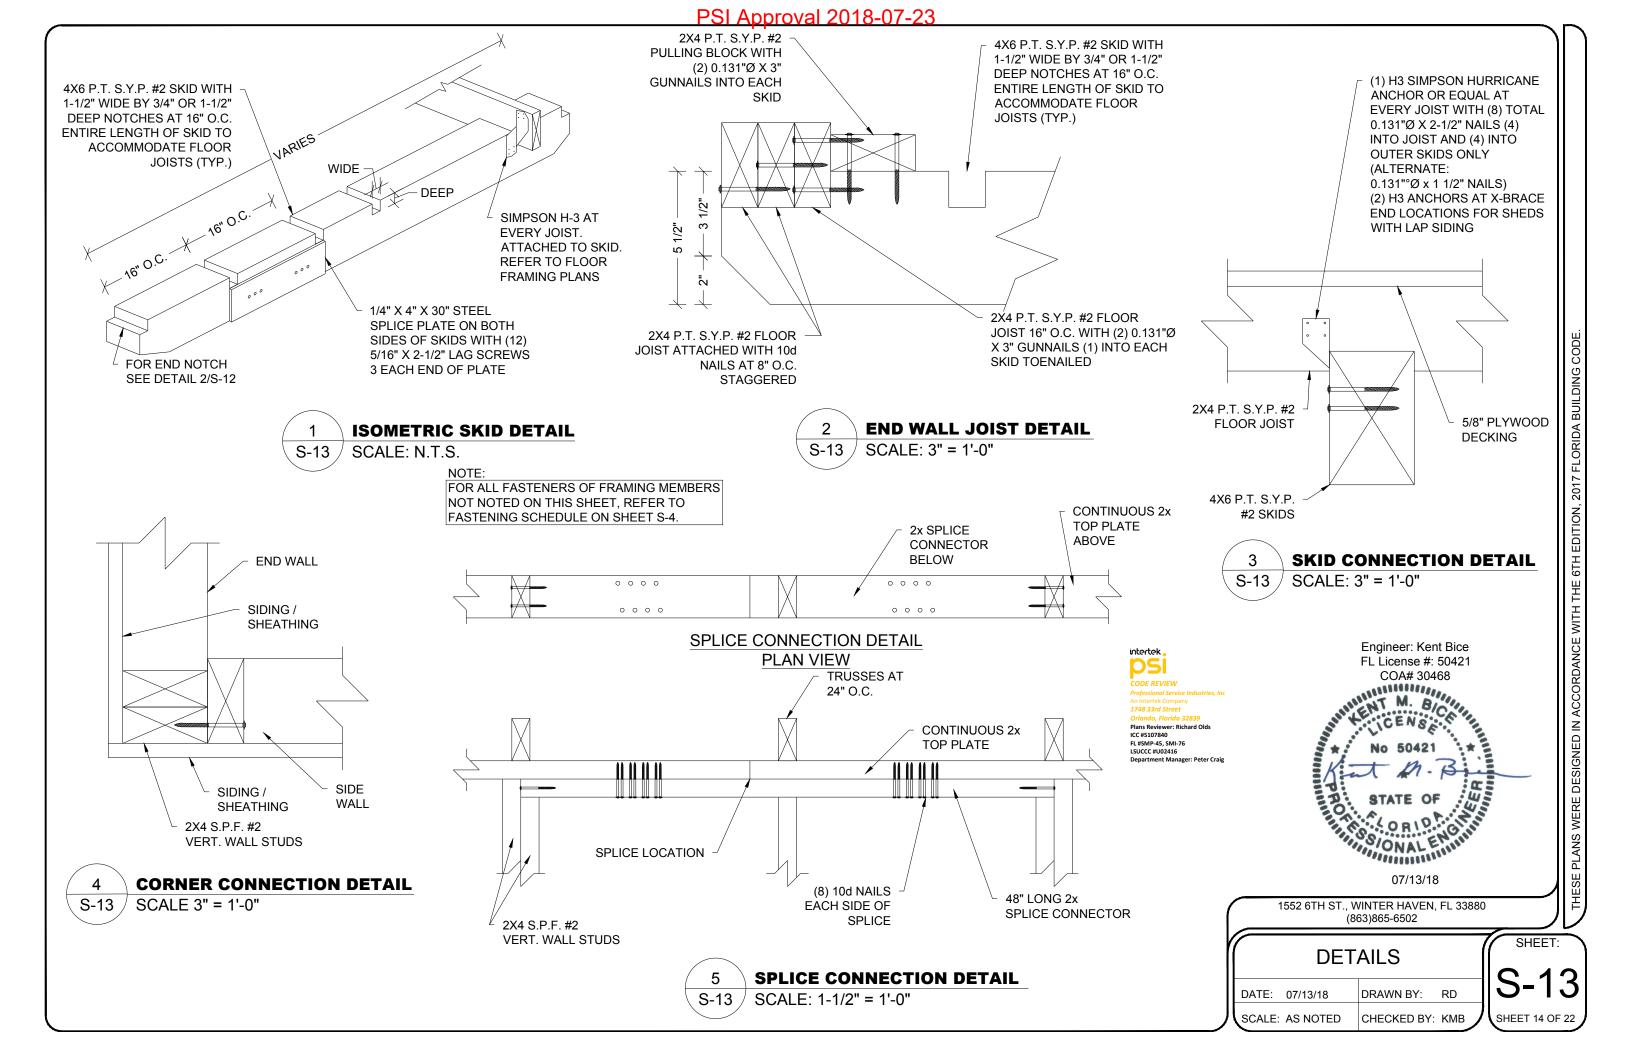

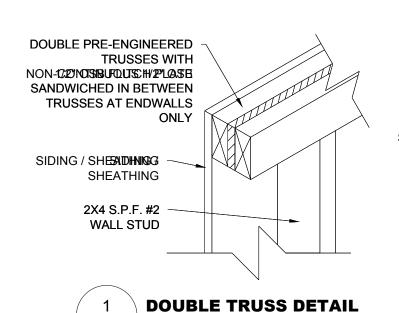

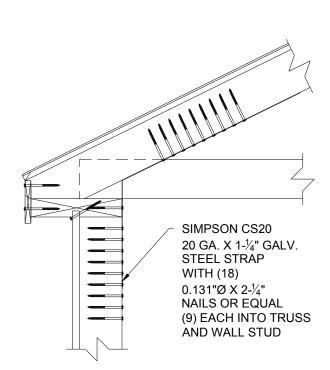

SCALE: 1-1/2" = 1'-0"

S-14



ASTM D 7158 CLASS H OR ASTM D 3161 CLASS F ASPHALT SHINGLES OVER APPROVED UNDERLAYMENT, METHOD OR DESIGN AS DESCRIBED UNDER GENERAL 7/16" OSB OR PLYWOOD SHEATHING FASTENED WITH **OPTIONAL LOFT FRAMING:** 2-3/8" X 0.113" NAILS AT 6" 2X4 S.P.F. #2 AT 24" O.C. MAX. O.C. IN FIELD AND EDGES FOR 7-11 1/2" & 9'-11 1/2" WIDE SHEDS. 2X6 S.P.F. #2 AT 24" O.C. MAX. FOR 11'-0" WIDE SHED. ATTACH TO TRUSS WITH (5) 0.131" Ø X 3" NAILS AT EACH END SIMPSON LTS12 WITH 1X4 S.Y.P. P.T. (12) TOTAL (6) EACH #2 FASCIA **END OR SIMPSON H8** WITH (8) TOTAL (4) EACH END 2X8 S.Y.P. #2 TOP 0.148"Ø X 1-½" PLATE NOTCHED TO **GUNNAILS OR EQUAL RECEIVE SIDING** INTO RAFTERS AND STUD WALLS / TOP PLATE. STRAP MAY BE BENT AROUND SIDING / SHEATHING. TOP PLATE IF WALL STUDS SEE SHEETS S-6 AND S-6A. ARE AT 16" O.C. ALTERNATE: 0.131" X 1-1/2" NAILS 2X4 S.P.F. #2 VERT. TOP CHORD WALL STUD OF TRUSS 2X4 FLOOR JOIST

**ALTERNATE WALL STUD TO TRUSS TOP CHORD AND FLOOR FASTENING DETAIL** S-14 SCALE: 1-1/2" = 1'-0"

2X4 BAND

**JOIST** 

0.131" X 3" NAILS AT 12" O.C 5 **COSMETIC PIECE ATTACHMEN** S-14 SCALE: NTS

S-14

SIDING /

SHEATHING

intertek

**ALTERNATE** 

SCALE: 1-1/2" = 1'-0"

COSMETIC OUTER 2X4 S.P.F. #2

ATTACH TO INNER 2X4 WITH

0.131" X 3" NAILS AT 12" O.C.

COSMETIC INNER 2X4 S.P.F

ATTACH TO TRUSS TOP CH

THRU SIDING / SHEATHING

ICC #5107840 FL #SMP-45, SMI-76 LSUCCC #U02416

1552 6TH ST., WINTER HAVEN, FL 33880 (863)865-6502

	DET	AILS	(	SHEET:
DATE:	07/13/18	DRAWN BY:	RD	S-14
SCALE:	AS NOTED	CHECKED BY:	кмв	SHEET 15 OF 22

SIMPSON CS

STEEL STRAP

NAILS OR EQUAL

AND WALL STUD

Engineer: Kent Bice FL License #: 50421

COA# 30468

William M. Dilling

11,8/ONAL ENTIN

07/13/18


(9) EACH INTO TRUSS


WITH (18) 0.131"Ø X 2-1/4"


WALL STUD TO LOFT FASTENING


20 GA. X 1-1/4" GALV.


FOR ALL FASTENING OF FRAMING MEMBERS NOT NOTED ON THIS SHEET, REFER TO FASTENING SCHEDULE ON SHEET S-4.

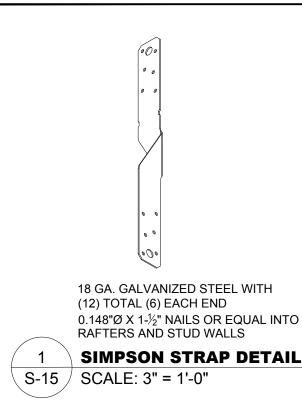

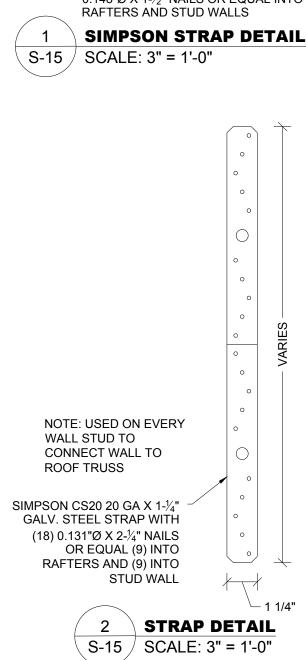

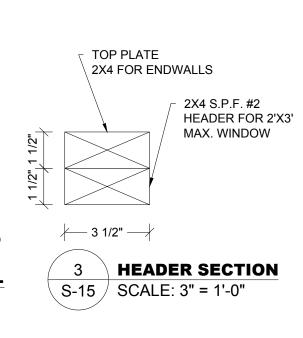

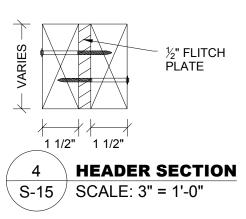

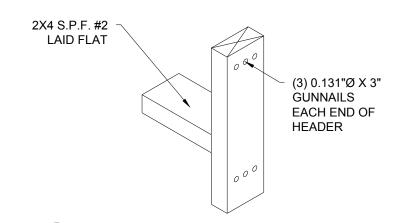


5 WINDOW HEADER AND SILL DETAIL
S-15 SCALE: N.T.S.
NOTE:

FOR MAX. 2'-0" WIDE X 3'-0" DEEP WINDOW.

FOR MAX. 4'-0" WIDE X 5'-10" DEEP OPENINGS IN SIDE WALL - (2) 2X4 S.P.F. #2 WITH 1/2" PLYWOOD FILLER. FOR MAX. 6'-0" WIDE X 5'-10" DEEP OPENINGS IN SIDE WALL - (2) 2X6 S.P.F. #2 WITH 1/2" PLYWOOD FILLER OR (2) 1-3/4" X 3-1/2" 1.9E MICROLLAM LVL FOR OPENINGS IN END WALL: (2) 2X4 S.P.F. #2 WITH 1/2" PLYWOOD FILLER. SIMPSON CS20 20GA. X 1-1/4" STRAP WRAPPED OVER HEADER. ATTACH STRAP TO EACH SIDE OF JACK STUD WITH 0.131"Ø X 2-1/4" GUNNAILS: (3) NAILS FOR UP TO 3'-0" WIDE OPENINGS (6) NAILS FOR UP TO 6'-0" WIDE OPENINGS (9) NAILS FOR UP TO 8'-0" WIDE OPENINGS

7 **HEADER WITH STRAP** S-15 / SCALE: N.T.S. NOTE:


FOR MAX. 6'-0" WIDE X 5'-10"
DEEP OPENING ON SIDE WALL
AND MAX. 8'-0" WIDE X 6'-8"
DEEP OPENING ON END WALL

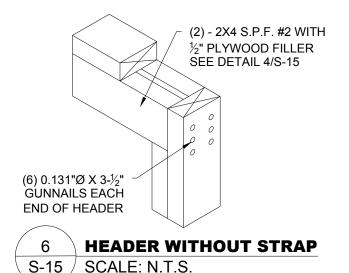

FOR MAX. 6'-0" WIDE X 6'-8"

DEEP OPENING ON END WALL

NOTE:

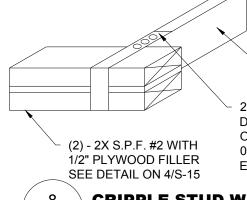

20 GA. STRAP TO WRAP UNDER DOOR HEADER TO OTHER SIDE OF CRIPPLE STUD WITH (3) 0.131"Ø X 2-1/4" GUNNAILS OR EQUAL ON EACH SIDE

2X4 CRIPPLE STUD

8 CRIPPLE STUD WITH STRAP DETAIL
S-15 SCALE: N.T.S. Engineer: Kent Bice

FL License #: 50421 COA# 30468

M. B

CENS

No 50421

STATE OF

ORL

07/13/18

1552 6TH S

F. REVIEW
sional Service Industries, Incertek Company
33rd Street
do, Florida 32839

1552 6TH ST., WINTER HAVEN, FL 33880 (863)865-6502

DETAILS

DATE: 07/13/18 DRAWN BY: RD

SCALE: AS NOTED CHECKED BY: KMB

SHEET:

SHEET:

SHEET:

SHEET:

SHEET:

SHEET:


SHEET:

SHEET:

Intertek .
DSI

CODE REVIEW
Professional Service Industries, Inc
An Intertek Company
1748 33rd Street
Orlando, Florida 32839
Plans Reviewer: Richard Olds
ICC #5107840
FL #SMP-45, SMI-76
LSUCCC #U02416
Department Manager: Peter Craig


PSI Approval 2018-07-23 9'-11½", OR 11'-0" FLOOR SKID 2X FLOOR JOIST SEE SHEET S-5 FOR DECKING SUPPORT 7'-111/2", **DOUBLE 2X JOISTS FLOOR JOISTS** 2 AT WALL TO PORCH SEE SHEET S-5 S-21 12'-0" MIN. LENGTH -**OPTIONAL STRAIGHT PORCH FLOOR FRAMING PLAN** S-16 SCALE: 1/4" = 1'-0" S-21 3 12'-0" MIN. OVERALL LENGTH S-21 5/4" X 6" S.Y.P. STD. P.T. FLOOR DECKING WALL STUD SEE SHEET S-5 Engineer: Kent Bice OPTIONAL 42" FL License #: 50421 HIGH GUARDRAIL FLOOR DECK COA# 30468 S-20 SEE SHEET S-5 P.T. 4X6 S.Y.P. #2 POST AT 6'-0" MAX. **SPACING** 4X4 S.P.F. #2 POST OR OPTIONAL POST (2) 2X4 S.P.F. #2 WITH WITH GUARDRAIL 1/2" FLITCH PLATE AND ONALEMIN P.T. 4X6 S.Y.P. #2 POST ON SIDE WALL FOR 4' PORCH - EXTEND TOP PLATE TO NOTES: 07/13/18 TOP OF POST WITH P.T. 2X4 S.Y.P #2 BEAM UNDER IT. ON SIDE WALL FOR 6' PORCH - (2) 1-3/4" X 3-1/2" 1.9E intertek. 1. P.T. 4X6 S.Y.P. #2 POST **PSI** 1552 6TH ST., WINTER HAVEN, FL 33880 MICROLLAM LVL BEAM OR P.T. (2) 2X6 S.P.F. #2 WITH IS SHOWN. 4X4 POST IS (863)865-6502 1/2" FLITCH PLATE BETWEEN THE PLIES CODE REVIEW **OPTIONAL** SHEET: FRAMING & FLOOR PLAN **OPTIONAL STRAIGHT** FOR STRAIGHT PORCH Plans Reviewer: Richard Olds ICC #5107840 FL #SMP-45, SMI-76 **PORCH FLOOR PLAN** S-16 SCALE: 1/4" = 1'-0" LSUCCC #U02416
Department Manager: Peter Craig DRAWN BY: RD DATE: 07/13/18 SCALE: AS NOTED CHECKED BY: KMB **SHEET 17 OF 22** 

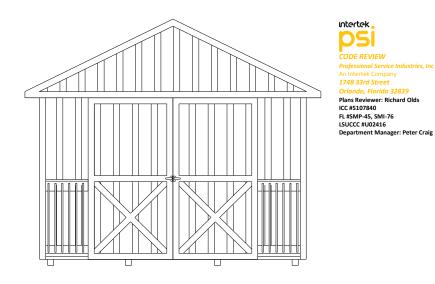

1 STI

# ENDWALL WITH OPTIONAL STRAIGHT PORCH ELEVATION

SCALE: 1/4" = 1'-0"

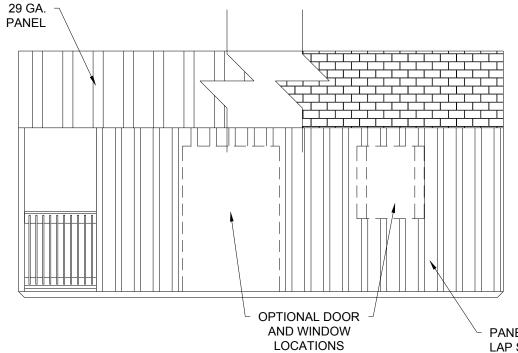

PANEL SIDING SHOWN.
LAP SIDING OPTIONAL.
SEE SHEET S-6A



# SIDEWALL WITH OPTIONAL STRAIGHT PORCH ELEVATION

SCALE: 1/4" = 1'-0"

Engineer: Kent Bice
FL License #: 50421
COA# 30468

M. BC

No 50421

STATE OF

OR

07/13/18

1552 6TH ST., WINTER HAVEN, FL 33880 (863)865-6502

# ELEVATIONS FOR STRAIGHT PORCH

DATE: 07/13/18 DRAWN BY: RD


SCALE: AS NOTED CHECKED BY: KMB

S-17
SHEET 18 OF 22

SHEET:

PSI Approval 2018-07-23 24'-0" MIN. LENGTH FOR 4'-0" PORCH; 26'-0" MIN. LENGTH FOR 6'-0" PORCH ├── <mark>4'-0"</mark> ── ├ (2) 2X4 FLOOR JOISTS S.Y.P. #2 AT WALL TO PORCH 4'-2" FLOOR SKID SEE SHEET S-5 -0" MAX. **FLOOR JOIST** 6'-0" MAX. 5 4 SEE SHEET S-5 S-21 S-21 10'-10" STANDARD S-21 12'-10" WITH OPTIONAL 6'-0" PORCH ON SIDE WALL FOR 4' PORCH - EXTEND TOP PLATE TO **OPTIONAL CLIPPED PORCH** TOP OF POST WITH P.T. 2X4 S.Y.P #2 BEAM UNDER IT. **FLOOR FRAMING PLAN** ON SIDE WALL FOR 6' PORCH - (2) 1-3/4" X 3-1/2" 1.9E S-18 SCALE: 1/4" = 1'-0" MICROLLAM LVL BEAM OR P.T. (2) 2X6 S.P.F. #2 WITH 1/2" FLITCH PLATE BETWEEN THE PLIES S-20 4X4 S.P.F. #2 POST OR (2) 2X4 S.P.F. #2 WITH 1/2" FLITCH PLATE OPTIONAL 42" Engineer: Kent Bice HIGH GUARDRAIL FL License #: 50421 COA# JU. COA# 30468 5/4" X 6" S.Y.P. STD. P.T. FLOOR DECKING intertek P.T. 4X6 POST 4X4 S.P.F. #2 POST OR SEE NOTES BELOW (2) 2X4 S.P.F. #2 WITH DOUBLE 2X4 VERTICAL 1/2" FLITCH PLATE STUDS AT ALL OPENING LOCATIONS Plans Reviewer: Richard Olds ICC #5107840 B ORIDAGINA

ORIDAGINA FL #SMP-45, SMI-76 LSUCCC #U02416 4'-0" — 3 WALL STUD NOTES: S-21 SEE SHEET S-5 10'-10" STANDARD 07/13/18 12'-10" WITH OPTIONAL 6'-0" PORCH 1. ADDITIONAL POSTS MAY BE ADDED ABOVE AND BEYOND THE AMOUNT SHOWN PROVIDED THE SPACING DOES NOT EXCEED 6'-0" O.C. 1552 6TH ST., WINTER HAVEN, FL 33880 (863)865-6502 2. P.T. 4X6 S.Y.P. #2 POST IS SHOWN 4X4 POST IS OPTIONAL. SHEET: FRAMING & FLOOR PLAN **OPTIONAL CLIPPED** FOR CLIPPED PORCH **PORCH FLOOR PLAN** DRAWN BY: RD DATE: 07/13/18 S-18 SCALE: 1/4" = 1'-0" SCALE: AS NOTED CHECKED BY: KMB **SHEET 19 OF 22**  PSI Approval 2018-07-23

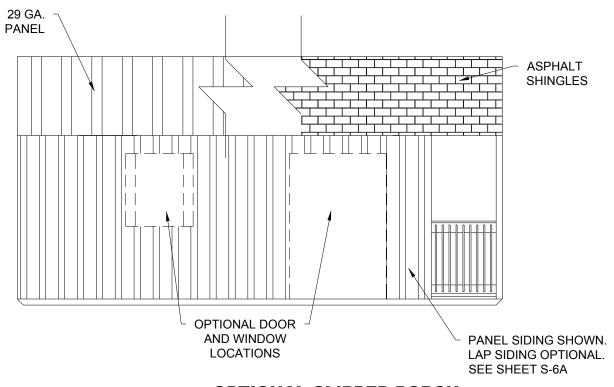

29 GA. **PANEL ASPHALT SHINGLES OPTIONAL** WINDOW


**OPTIONAL CLIPPED PORCH** SIDEWALL ELEVATION

SCALE: 1/4" = 1'-0"

## **OPTIONAL CLIPPED PORCH SIDEWALL ELEVATION**

SCALE: 1/4" = 1'-0"

S-19

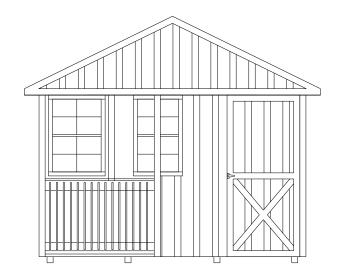

**OPTIONAL CLIPPED PORCH** 3 **ENDWALL ELEVATION** S-19 /

SCALE: 1/4" = 1'-0"



1552 6TH ST., WINTER HAVEN, FL 33880 (863)865-6502

**ELEVATIONS FOR CLIPPED PORCH** 

DATE: 07/13/18 DRAWN BY: RD SCALE: AS NOTED CHECKED BY: KMB

SHEET: S-19 SHEET 20 OF 22

PSI Approval 2018-07-23 2-PLY TRUSS 2-PLY TRUSS BOTTOM **BOTTOM CHORD** ATTACHMENT PER CHORD SHEET S-13 P.T. (2) 1-3/4" X 3-1/2" 1.9E MICROLLAM LVL BEAM OR P.T. (2) 2X6 S.P.F. #2 WITH 1/2" FLITCH 2X8 TOP PLATE PLATE BETWEEN THE PLIES **EXTEND FROM BUILDING** LOFT JOIST 2X4 BEAM (2) 1/4" X 6" LAG **SCREWS THROUGH** P.T. PLYWOOD CEILING **TOP PLATES INTO** AT PORCH ONLY (2) 1/4" LAG SCREWS THROUGH HEADER / 5/8" P.T. PLYWOOD WRAP 4X6 P.T. POST TOP PLATE WITH 2" MIN. PENETRATION INTO AROUND BEAM FOR ALL PREDRILL 0.15" MIN. PORCH TOP

EXPOSED NON-P.T. WOOD TOP PLATE EXTEND POST, PREDRILL 0.15" MIN. DIA, HOLE FOR DIA. HOLE FOR FROM BUILDING SCREW. MIN. 7/8" EDGE DISTANCE. SCREW. 2X4 BEAM ALTERNATE: SIMPSON BC4Z WITH **PLATE DETAIL** MIN. 7/8" END DISTANCE (6) 0.162" X 2-1/2" NAILS EACH S-21 SCALE: 1 1/2" = 1'-0" INTO POST AND HEADER ATTACHMENT PER SHEET S-13 **HEADER IN SIDE WALL TO** 4X6 P.T. POST BEND BOTTOM OF STRAP AROUND **POST CONNECTION - 6'-0" PORCH** BEAM IF NECESSARY. SCALE: 1 1/2" = 1'-0" **HEADER IN SIDE WALL TO POST CONNECTION - 4'-0" PORCH** SIMPSON PC4Z WITH 0.148" X 5/8" P.T. PLYWOOD CEILING 3" NAILS - (10) INTO TRUSS / SCALE: 1 1/2" = 1'-0" AT PORCH ONLY HEADER AND (8) INTO POST ATTACHED TO JOIST WITH LOFT JOIST ALTERNATE: SIMPSON BC4Z WITH 0.113" X 2-3/8" NAILS (6) 0.162" X 1-1/2" NAILS EACH intertek AT 6" O.C. IN FIELD INTO POST AND HEADER AND EDGES. 5/8" P.T. PLYWOOD Engineer: Kent Bice WRAP AROUND BEAM (2) 2X TRUSS WITH FL License #: 50421 FOR ALL EXPOSED ICC #5107840 1/2" FLITCH PLATE OR COA# 30468 FL #SMP-45, SMI-76 NON-P.T. WOOD **HEADER INTERIOR POST** TOP PLATE EXTEND TRUSS / HEADER TO FROM BUILDING INTERIOR POST CONNECTION 2X4 BEAM ATTACHED TO EXTENDED TOP PLATE S-21 SCALE: 1 1/2" = 1'-0" (2) 0.131" X 3" FROM BUILDING **TOENAIL FROM BLOCKING INTO** OR LENGT SIMPSON ABW46Z W/ **JOIST** (10) 0.148"X1-1/2" NAILS FOR FLOOR JOIST **FLOOR JOIST** 4X6 POST. ABW44Z W/(8) 0.148"X1-1/2" NAILS FOR 07/16/18 **4X4 POST** (2) 0.131" X 3" TOENAIL FROM **BLOCKING INTO BLOCKING BLOCKING** 1/2" X 4" LAG SCREW **JOIST** 1552 6TH ST., WINTER HAVEN, FL 33880 (863)865-6502 SHEET: 4X6 P.T. SKID **DETAILS BLOCKING BLOCKING** ATTACHMENT DETAIL **ATTACHMENT DETAIL SECTION** DATE: 07/13/18 DRAWN BY: RD SCALE: 1 1/2" = 1'-0" SCALE: 1 1/2" = 1'-0" S-21 SCALE: 1 1/2" = 1'-0" SCALE: AS NOTED CHECKED BY: KMB **SHEET 22 OF 22** 

# COOK PORTABLE WAREHOUSES

100 DOUGLAS ST. VALDOSTA, GA 31601 132 CENTRAL INDUSTRIAL ROW, PURVIS, MS 39475 1398 HWY 95 NORTH, BASTROP, TX 78602

## **TIEDOWN PLANS**

STATE OF FLORIDA

#### **GENERAL NOTES**

- 1. THE CONTRACTOR SHALL BE RESPONSIBLE FOR VERIFYING ALL EXISTING CONDITIONS.
- 2. THE CONTRACTOR SHALL BE RESPONSIBLE FOR COORDINATING ARCHITECTURAL, STRUCTURAL, MECHANICAL, AND ELECTRICAL DETAIL AND DIMENSIONS. ANY DISCREPANCIES BETWEEN SUCH DETAILS AND DIMENSIONS SHALL BE REPORTED TO THE ENGINEER PRIOR TO PROCEEDING WITH THE WORK.
- 3. THE CONTRACTOR SHALL BE RESPONSIBLE FOR ERECTION PROCEDURE AND SEQUENCE TO INSURE THE INTEGRITY OF THE BUILDING AND ITS COMPONENT PARTS DURINGCONSTRUCTION.
- 4. THESE PLANS HAVE BEEN PREPARED PER REGULATIONS OF THE 6TH EDITION, 2017 FLORIDA BUILDING CODE. THE WORK OF ALL CONTRACTORS SHALL COMPLY WITH THE REQUIREMENTS SET FORTH IN THE AFOREMENTIONED CODE. NO DEVIATIONS FROM THE WORK SHOWN OR REASONABLY IMPLIED SHALL BE UNDERTAKEN WITHOUT THE ENGINEERS WRITTEN CONSENT A COPY OF WHICH WILL BE FILED WITH THE CONSTRUCTION OFFICIAL.
- ANY CHANGES TO OR DEVIATIONS FROM THESE DRAWINGS SHALL NOT BE MADE WITHOUT WRITTEN CONSENT FROM THE ENGINEER.
- 6. THESE DRAWINGS ARE THE PROPERTY OF THE ENGINEER AND SHALL NOT BE USED WITHOUT HIS CONSENT. DRAWINGS SHALL NOT BE USED FOR ISSUE OF BUILDING PERMIT UNLESS SIGNED AND SEALED BY THE ENGINEER.
- 7. THE OWNER AND THE CONTRACTOR SHALL HOLD HARMLESS THE ENGINEER FROM AND AGAINST ALL LIABILITY CLAIMS, DAMAGES, LOSSES, AND EXPENSES INCLUDING LEGAL FEES ARISING OUT OF OR RESULTING FROM ERRORS OR OMISSIONS IN THE PERFORMANCE OF THE WORK BY THE CONTRACTOR. THE DRAWINGS SHOW THE GENERAL ARRANGEMENTS AND EXTENT OF THE WORK. AS THE WORK PROGRESSES, THE OWNER AND THE CONTRACTOR, AT NO EXTRA COSTS, SHALL MAKE THE MODIFICATIONS TO MAKE THE PARTS ALIGN.
- 8. ALL WORK AND MATERIALS SHALL MEET THE REQUIREMENTS OF LOCAL AND STATE CODES AND THE SPECS OF THE NATIONAL BOARD OF FIRE UNDERWRITERS. CONTRACTORS SHALL CHECK AND VERIFY ALL PLAN DIMENSIONS AND CONDITIONS BEFORE PROCEEDING WITH CONSTRUCTION. HE SHALL REPORT ANY DISCREPANCIES TO THE ENGINEER FOR CORRECTION PRIOR TO BEGINNING ANY WORK. THE DISCOVERY OF DISCREPANCIES AFTER THE BEGINNING OF WORK WILL BE EVIDENCE OF FAULTY WORK. AND SHALL BE THE RESPONSIBILITY OF THE CONTRACTOR. DO NOT SCALE DRAWINGS. ALL WRITTEN DIMENSIONS GOVERN.
- 9. THE CONTRACTOR FOR THIS PROJECT SHALL INCLUDE ALL MATERIALS AND LABOR REQUIRED TO COMPLETE THE TOTAL PROJECT. THE CONTRACTOR SHALL FURNISH AND PAY FOR ALL MATERIALS. TOOLS, EQUIPMENT, LABOR, MACHINERY, TRANSPORTATION, HEAT, WATER, UTILITIES, AND ALL OTHER FACILITIES AND SERVICES REQUIRED FOR THE SAFE AND PROPER EXECUTION AND COMPLETION OF THE WORK.
- 10. THE DOCUMENTS SHOW AN OVERVIEW OF THE WORK REQUIRED UNDER THIS CONTRACT AND RELATED REQUIREMENTS AND CONDITIONS THAT WILL IMPACT THE PROJECT. ALL DRAWINGS ARE COMPLIMENTARY. THE DRAWINGS GENERALLY SHOW THE INTENT OF THE OVERALL COMPLEXITY AND CONCEPTS OF THE PROJECT, AND DO NOT NECESSARILY SHOW ALL DETAILS AND CONDITIONS. ALL NEW INTERIOR CONCRETE SLABS AND FOUNDATION WALLS AND FOOTINGS SHALL HAVE SOIL POISONING UNDER NEW WORK AND SHALL BE INSTALLED BY A LICENSED CONTRACTOR.
- 11. ALL WORK SHALL BE COMPLETED IN ACCORDANCE WITH ALL STATE AND DEPARTMENT OF AGRICULTURE, STRUCTURAL PEST CONTROL DIVISION REGULATIONS, RULES DEFINITIONS AND REQUIREMENTS.
- 12. THE CONTRACTOR SHALL BE RESPONSIBLE FOR VERIFYING AND MAINTAINING ALL EXISTING SETBACKS, EASEMENTS, AND ANY DEED RESTRICTIONS.
- 13. THE CONTRACTOR SHALL BE RESPONSIBLE FOR FINAL CLEANUP AND SHALL INCLUDE THE SITE, AND THE BUILDING. THE ENTIRE PROJECT SHALL BE LEFT IN A NEW, CLEAN CONDITION.
- 14. TIEDOWNS SHOWN INCLUDING STRAP AND ANCHOR, AND BEARING PADS ARE BASED ON AN ALLOWABLE BEARING PRESSURE OF 2500 PSF. ANY SOIL CONDITIONS THAT MAY DIFFER FROM THIS MUST BE BROUGHT TO THE ATTENTION OF THE ENGINEER.
- 15. THE CONTRACTOR IS RECOMMENDED TO USE A SOIL TEST PROBE TO DETERMINE THE SOIL CLASS. WHERE SUCH TESTING IS NOT CONDUCTED, IT IS RECOMMENDED TO USE A 60" GALVANIZED ANCHOR WITH STABILIZER PLATE.
- 16. CONCRETE PADS UNDER SKIDS ARE OPTIONAL AND SHALL BE LOCATED ON UNDISTURBED SOIL OR PROPERLY COMPACTED FILL MATERIAL. COMPACTED SOIL SHALL BE TESTED TO A MINIMUM OF 95% PROCTOR IN ACCORDANCE WITH ASTM D1557. FILL MATERIAL SHALL BE FREE OF VEGETATION AND FOREIGN MATERIAL.
- 17. FINISH GRADE SHALL BE SLOPED AWAY FROM THE FOUNDATION FOR DRAINAGE. PROVISIONS SHALL BE MADE TO PREVENT SOIL EROSION UNDER THE PAD AND DIRECT WATER AWAY FROM IT.

Sheet Index			
SHEET NUMBER	SHEET TITLE		
F-1	TIEDOWN GENERAL NOTES		
F-2	TIEDOWN SCHEDULE FOR EXPOSURE B		
F-3	TIEDOWN SCHEDULE FOR EXPOSURE C		
F-4	GROUND ANCHOR SCHEDULE		
F-5	TIEDOWN SECTIONS		
F-6	OPTIONAL PAD DETAILS		



1552 6TH ST., WINTER HAVEN, FL 33880 (863)865-6502

## GENERAL NOTES

DATE: 04/10/18 DRAWN BY: RD

SCALE: AS NOTED CHECKED BY: KMB

SHEET:

F-1

SHEET 1 OF 6

TIEDOWN SCHEDULE FOR 111 TO 130 MPH WIND SPEED, EXPOSURE "B"												"B"	
BLDG	1	NUMBE	R OF	TIEDO	OWNS	PER (	OUTEF	RSKID	BY BU	ILDING	S LENG	STH (F	T)
WIDTH	8'-0"	10'-0"	12'-0"	14'-0"	16'-0"	18'-0"	20'-0"	22'-0"	24'-0	26'-0"	28'-0"	30'-0"	32'-0"
6'-0"	2	2	2	N/A	N/A	N/A	N/A	N/A	N/A	N/A	N/A	N/A	N/A
7'-11" 1/2"	2	2	2	2	2	2	2	2	2	N.A.	N.A.	N.A.	N.A.
9'-11" 1/2"	2	2	2	2	2	2	2	2	2	2	2	2	N.A.
11'-0"	2	2	2	2	2	2	2	2	2	2	2	2	2

TIEDOWN SCHEDULE FOR 131 TO 160 MPH WIND SPEED, EXPOSURE "B"													"B"
BLDG NUMBER OF TIEDOWNS PER OUTER SKID BY BUILDING LENGTH (FT									T)				
WIDTH	8'-0"	10'-0"	12'-0"	14'-0"	16'-0"	18'-0"	20'-0"	22'-0"	24'-0	26'-0"	28'-0"	30'-0"	32'-0"
6'-0"	2	2	2	N/A	N/A	N/A	N/A	N/A	N/A	N/A	N/A	N/A	N/A
7'-11" 1/2"	2	2	2	2	2	2	3	3	3	N.A.	N.A.	N.A.	N.A.
9'-11" 1/2"	2	2	2	2	2	2	2	3	3	3	3	3	N.A.
11'-0"	2	2	2	2	2	2	2	3	3	3	3	3	4

- 1. PROVIDE A MINIMUM OF ONE TIEDOWN STRAP AND ANCHOR AT EACH END OF EACH OUTER SKID. EVENLY SPACE THE REMAINING TIEDOWNS.
- 2. WRAP THE STRAP AROUND THE SKID AND ATTACH TO ANCHOR.
- 3. MAXIMUM PERMITTED ANGLE OF STRAP FROM VERTICAL IS 45 DEGREES. LOCATE ANCHORS VERTICALLY INTO THE GROUND.



1552 6TH ST., WINTER HAVEN, FL 33880 (863)865-6502

# TIEDOWN SCHEDULE FOR EXPOSURE B

DATE: 04/10/18 DRAWN BY: RD

SCALE: AS NOTED CHECKED BY: KMB

SHEET:

F-2
SHEET 2 OF 6

TIEDO	WN S	SCHE	DULE	FOR	111 <sup>-</sup>	ΓΟ 13	0 MPI	H WINI	D SPE	EED, E	EXPOS	SURE	"C"
BLDG WIDTH													T)
VVIDIII	8'-0"	10'-0"	12'-0"	14'-0"	16'-0"	18'-0"	20'-0"	22'-0"	24'-0	26'-0"	28'-0"	30'-0"	32'-0"
6'-0"	2	2	2	N/A	N/A	N/A	N/A	N/A	N/A	N/A	N/A	N/A	N/A
7'-11" 1/2"	2	2	2	2	2	2	2	2	2	N.A.	N.A.	N.A.	N.A.
9'-11" 1/2"	2	2	2	2	2	2	2	2	2	2	3	3	N.A.
11'-0"	2	2	2	2	2	2	2	2	2	2	3	3	3

TIEDO	WN S	SCHE	DULE	FOR	131 <sup>-</sup>	TO 16	60 MPI	H WIN	D SPE	EED, E	EXPOS	SURE	"C"
BLDG WIDTH	ı	NUMBE	ER OF	TIEDO	OWNS	PER	OUTEF	R SKID	BY BU	ILDING	S LENC	STH (F	T)
WIDIN	8'-0"	10'-0"	12'-0"	14'-0"	16'-0"	18'-0"	20'-0"	22'-0"	24'-0	26'-0"	28'-0"	30'-0"	32'-0"
6'-0"	2	2	2	N/A	N/A	N/A	N/A	N/A	N/A	N/A	N/A	N/A	N/A
7'-11" 1/2"	2	2	2	3	3	3	4	4	4	N.A.	N.A.	N.A.	N.A.
9'-11" 1/2"	2	2	2	2	2	3	3	3	3	3	4	4	N.A.
11'-0"	2	2	2	2	2	3	3	3	3	3	4	4	4

- 1. PROVIDE A MINIMUM OF ONE TIEDOWN STRAP AND ANCHOR AT EACH END OF EACH OUTER SKID. EVENLY SPACE THE REMAINING TIEDOWNS.
- 2. WRAP THE STRAP AROUND THE SKID AND ATTACH TO ANCHOR.
- 3. 3. MAXIMUM PERMITTED ANGLE OF STRAP FROM VERTICAL IS 45 DEGREES. LOCATE ANCHORS VERTICALLY INTO THE GROUND.



1552 6TH ST., WINTER HAVEN, FL 33880 (863)865-6502

## TIEDOWN SCHEDULE FOR EXPOSURE C

DATE: 04/10/18 DRAWN BY: RD

SCALE: AS NOTED CHECKED BY: KMB

F-3
SHEET 3 OF 6

SHEET:

GROUND ANCHOR SCHEDULE										
MODEL#	PART#	DESCRIPTION	SOIL CLASS							
M12H5/8	59080 / 59081	48" X 5%" ROD WITH (1) 6" HELIX	4A							
M12H3/4	59085 / 59094	48" X ¾" ROD WITH (1) 6" HELIX	4A							
M1423/4	59128	42" X $^3\!\!4$ " ROD WITH (2) 4" HELIX	4A							
M1483/4	59086	48" X $\frac{3}{4}$ " ROD WITH (2) 4" HELIX	4A							
M12H64	59250	36" X $^3\!\!4$ " ROD WITH (1) 4" HELIX AND (1) 6" HELIX	4A							
N/A	59065	EYE ANCHOR - 48" X $^{5}\!\!$ " WITH (1) 6" HELIX	4A							
N/A	59045	EYE ANCHOR - 48" X $^3\!\!/_{\!\!4}$ " WITH (1) 6" HELIX	4A							
M607	59099	60" X ¾" WITH (1) 7" HELIX	4B							
N/A	59040	EYE ANCHOR - 60" X $^3\!\!/_{\!\!4}$ " WITH (1) 8" HELIX	4B							

#### NOTES:

- 1. ALL APPROVED ANCHORS LISTED ABOVE ARE MANUFACTURED BY TIE DOWN ENGINEERING.
- 2. THE CONTRACTOR MAY USE AN APPROVED EQUIVALENT WITH APPROVAL FROM THE EOR.
- 3. ANCHORS SHALL BE INSTALLED PER MANUFACTURER INSTRUCTIONS.

FL License #: 50421
COA# 30468

M. 8
CENS
No 50421
STATE OF

Engineer: Kent Bice

04/12/18

1552 6TH ST., WINTER HAVEN, FL 33880 (863)865-6502

# GROUND ANCHOR SCHEDULE


DATE: 04/10/18 DRAWN BY: RD

SCALE: AS NOTED CHECKED BY: KMB

SHEET:

F-4
SHEET 4 OF 6

ANS WERE DESIGNED IN ACCORDANCE WITH THE 6TH EDITION 2017 FLORIDA BLIII DING CO

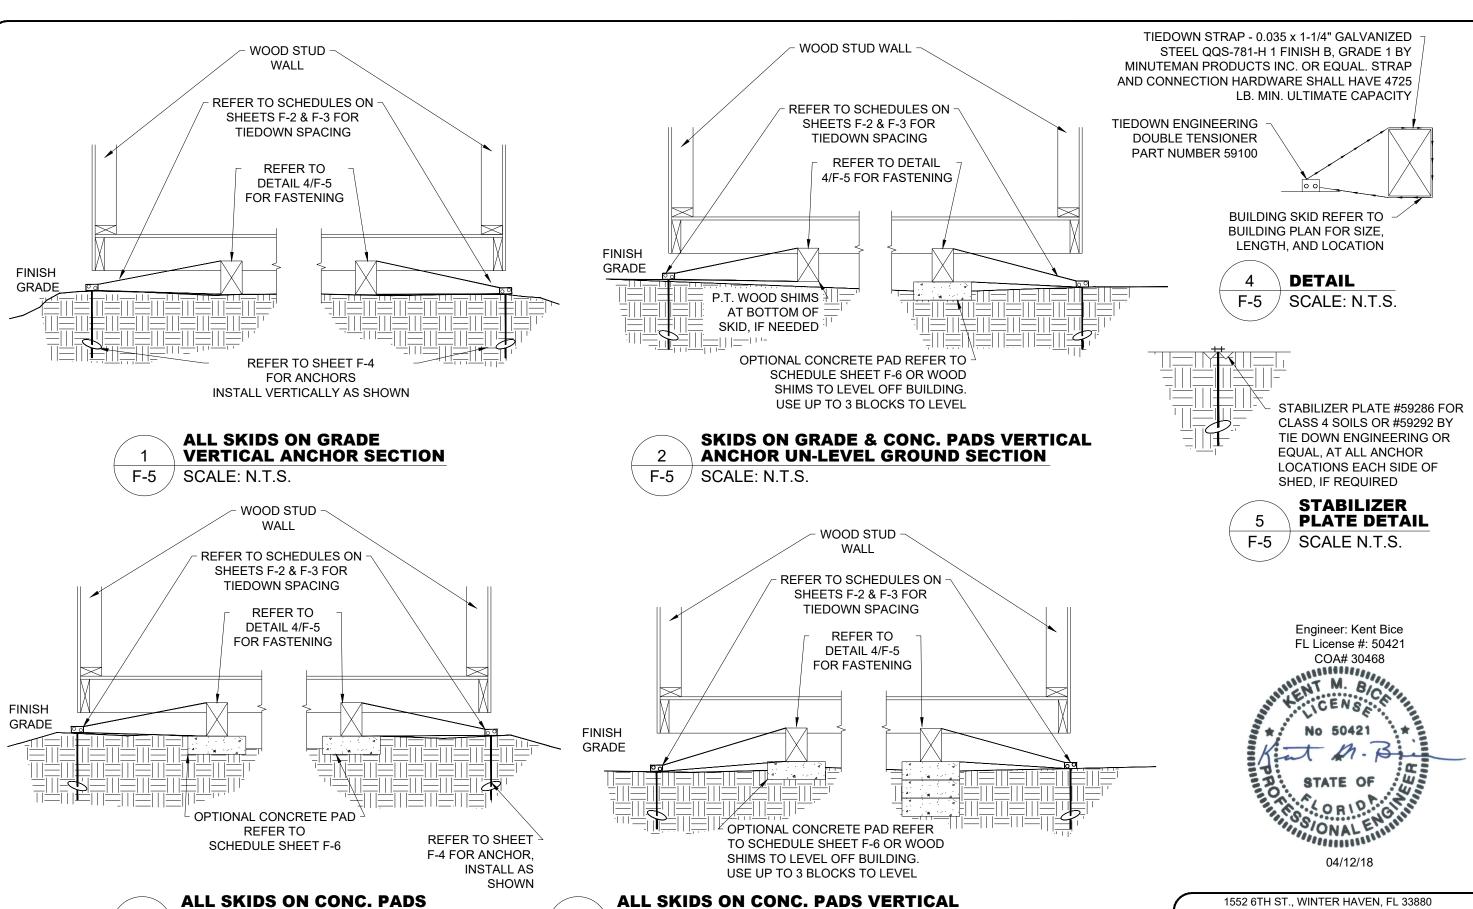

**ANCHOR UN-LEVEL GROUND SECTION** 

SCALE N.T.S.

**VERTICAL ANCHOR SECTION** 

SCALE: N.T.S.

1552 6TH ST., WINTER HAVEN, FL 33880 (863)865-6502

# **TIEDOWN SECTIONS**

DRAWN BY: RD CHECKED BY: KMB

SHEET 5 OF 6

SHEET:


DATE: 04/10/18 SCALE: AS NOTED

#### NOTE:


- 1. 4" MIN. THICK, 2500 PSI MIN. CONCRETE PADS ARE OPTIONAL.
- 2. DIMENSIONS SHOWN ARE NOMINAL.
- 3. TIEDOWNS ARE REQUIRED MIN. (4) PER BUILDING, (1) AT EACH CORNER SHEARWALL (SW#).
- 4. REFER TO SCHEDULES ON SHEET F-2 & F-3 FOR TIEDOWN SPACING AND SCHEDULES ON THIS SHEET FOR OPTIONAL PAD LOCATION.
- 5. SPACE OPTIONAL PADS AT EACH END OF EACH SKID AND EQUALLY IN-BETWEEN.
- 6. LOCATE PAD CENTERED UNDER THE SKID.

			EXP	OSUF	RES, A	AND 4	40 PS	F FL	OOR	LOAD	)			
BLDG	WIDTH		NUMB	ER OF	PADS	REQUI	RED B	Y BUILE	DING LE	ENGTH	UNDE	R EACH	1 SKID	
BLBO	***************************************	8'-0"	10'-0"	12'-0"	14'-0"	16'-0"	18'-0"	20'-0"	22'-0"	24'-0"	26'-0"	28'-0"	30'-0"	32'-0'
	6'-0"	3	3	3	N/A	N/A	N/A	N/A	N/A	N/A	N/A	N/A	N/A	N/A
SINGLE WIDE	7'-11 ½"	3	3	3	4	4	4	5	5	5	N.A.	N.A.	N.A.	N.A.
UNITS	9'-11 ½"	2	3	3	3	3	4	4	4	4	5	5	5	N.A.
	11'-0"	2	3	3	3	3	4	4	4	4	5	5	5	5


16" X 16" X 4" OR (2) 16" X 8" X 4" PAD SCHEDULE FOR ALL WIND SPEEDS,

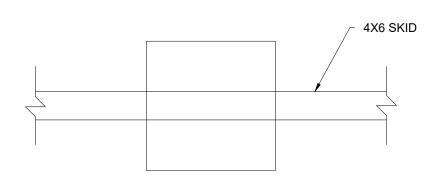




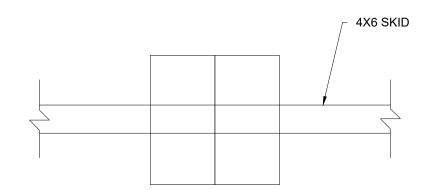

2 **(2) 16"X8"X4" PAD DETAIL** F-6 SCALE: N.T.S.

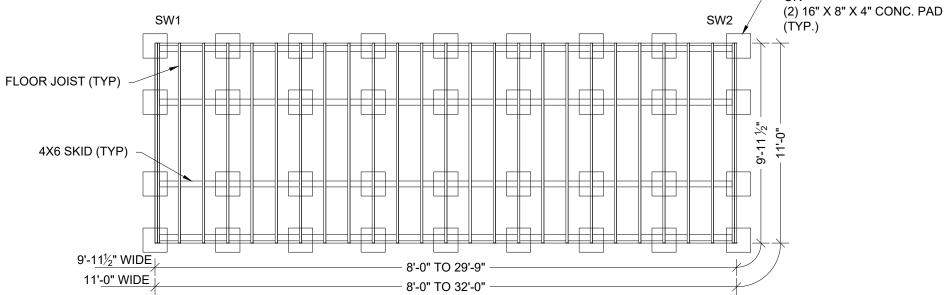

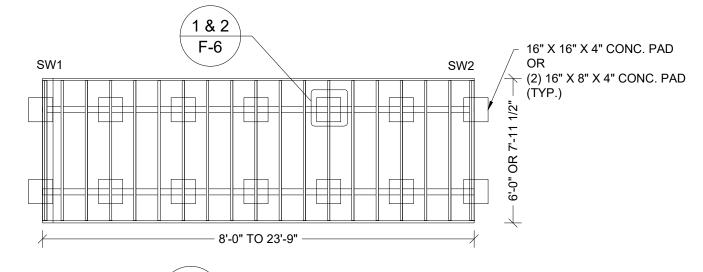

F-6 SCALE: N..T.S.

Engineer: Kent Bice
FL License #: 50421
COA# 30468

N. 50421
STATE OF

04/12/18

16" X 16" X 4" CONC. PAD

1552 6TH ST., WINTER HAVEN, FL 33880 (863)865-6502

OPTIONAL PAD DETAILS

DATE: 04/10/18 DRAWN BY: RD

SCALE: AS NOTED CHECKED BY: KMB

SHEET: **F-6**SHEET 6 OF 6